

EXISTING SIGNAGE

EXISTING CONCRETE PAVING

SIDEWALK AROUND BLDG

NEW CURB AND GUTTER

SIDEWALK SEE ARCH PLANS FOR

ARAPAHO RD RION WAY BELTLINE RD BELTWAY DR **VICINITY MAP**

SITE SU	MMARY	
ZONING	PD	
PROPOSED USE	RESTAURANT AND BREWER	
BUILDING		
BLDG S.F.	6,647 S.F.	
BACK PORCH PATIO	1,516 S.F.	
BAR PATIO	1,325 S.F.	
SMOKE SHED	600 S.F.	
TOTAL BLDG S.F. W/PATIO'S	10,088 S.F.	
BUILDING HEIGHT	1 STORY - 20'	
TOTAL LOT AREA	76,286 S.F.	
TOTAL ACREAGE	1.75 AC	
IMPERVIOUS AREA	66,224 S.F.	
% IMPERVIOUS	86.8%	
EXISTING OPEN SPACE	9,583 S.F.	
LANDSCAPE/OPEN SPACE AREA	10,062 S.F.	
% LANDSCAPE AREA	13.2%	

	PARKING SU	JMMARY
	PARKING REQUIRED 1/70 S.F.	144 SPACES
	PARKING PROVIDED	141 SPACES
	PARKING PROVIDED (IN ESMT)	13 SPACES
	TOTAL PARKING PROVIDED	154 SPACES
	H/C PARKING REQUIRED	6 SPACES
([H/C PARKING PROVIDED	6 SPACES

NOTE: HANDICAP PARKING IS PROVIDED IN ACCORDANCE WITH ADA STANDARDS

TOWN OF ADDISON SITE PLAN NOTES:

- 1. ANY REVISION TO THIS PLAN WILL REQUIRE TOWN APPROVAL AND WILL REQUIRE REVISIONS TO ANY CORRESPONDING PLANS TO AVOID CONFLICTS BETWEEN
- 2. OPEN STORAGE WHERE PERMITTED SHALL BE SCREENED IN ACCORDANCE WITH THE ZONING ORDINANCE.
- 3. BUILDINGS WITH AN AGGREGATE SUM OF 5,000 SQUARE FEET OR GREATER ON A LOT SHALL HAVE AUTOMATIC FIRE SPRINKLERS INSTALLED THROUGHOUT ALL STRUCTURES. ALTERNATIVE FIRE PROTECTION MEASURES MAY BE APPROVED BY THE FIRE DEPARTMENT.
- 4. ALL SIGNAGE IS SUBJECT TO TOWN APPROVAL.
- 5. ALL FENCES AND RETAINING WALLS SHALL BE SHOWN ON THE SITE PLAN AND AREA SUBJECT TO BUILDING INSPECTION DIVISION APPROVAL.

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DALL, DDISO

APPROVED DENIED

See the Staff Approval Letter or Council Result Memo for any

conditions associated with the

approval of the project.

KIRK & ASSOCIATES ARCHITECTURE
INTERIOR DESIGN
P L A N N I N G

5931 GREENVILLE AVE #772

DALLAS, TEXAS 75206

PHONE 214-912-7642 kirkarch1@aol.com

www.kirkarchitecture.com

DEVELOPER PROPERT

JAK'D MANAGEMENT
GROUP, LLC
CLINT NORTON
5814 Coolwater Cove
DALLAS, TEXAS 75252
Cell: 214-546-9999
Email: clint@oakdbbq.com
EMARCE SARNETT/ADDISON
LTD.
ELLIOT B. BARNETT
3132 FOREST PARK BLVI
FUNORTH, TEXAS 751
Cell: 214-393-3515
Email: clint@oakdbbq.com

ARCHITECT

Date

COUNCIL

	REVISIONS					
No	Description	Date				
		·				

ISSUE DATE

SHEET TITLE

FOR COUNCIL REVIEW

02/26/21

S.U.P. **SITE PLAN**

SHEET NO.

BOUSQUET GROUP

SUP SITE PLAN FOR OAK'D BBQ LOT 2, BLOCK A OF THE ADDISON OAKS ADDITION, VOL 89166, PG 1974, MRDCT

Being Lot 2 of Addison Oaks Addition to the City of Addison, Dallas County Texas. According to the Plat thereof recorded under Volume 89166 Page 1974, Map Records, Denton County, Texas.

Town of Addison Project Number 1823-Z

Engineer Information:


Texas Firm No. F-8942

75028

The Bousquet Group, LLC 5104 Connors Dr. Flower Mound, TX

972.207.8077

SEE ARCHITECTURAL PLANS FOR EXACT **BUILDING DIMENSIONS, CONTRACTOR TO NOTIFY ENGINEER OF ANY DISCREPANCIES** EXISTING IRRIGATION WATER METER NEW FIRE SPRINKLER LINE

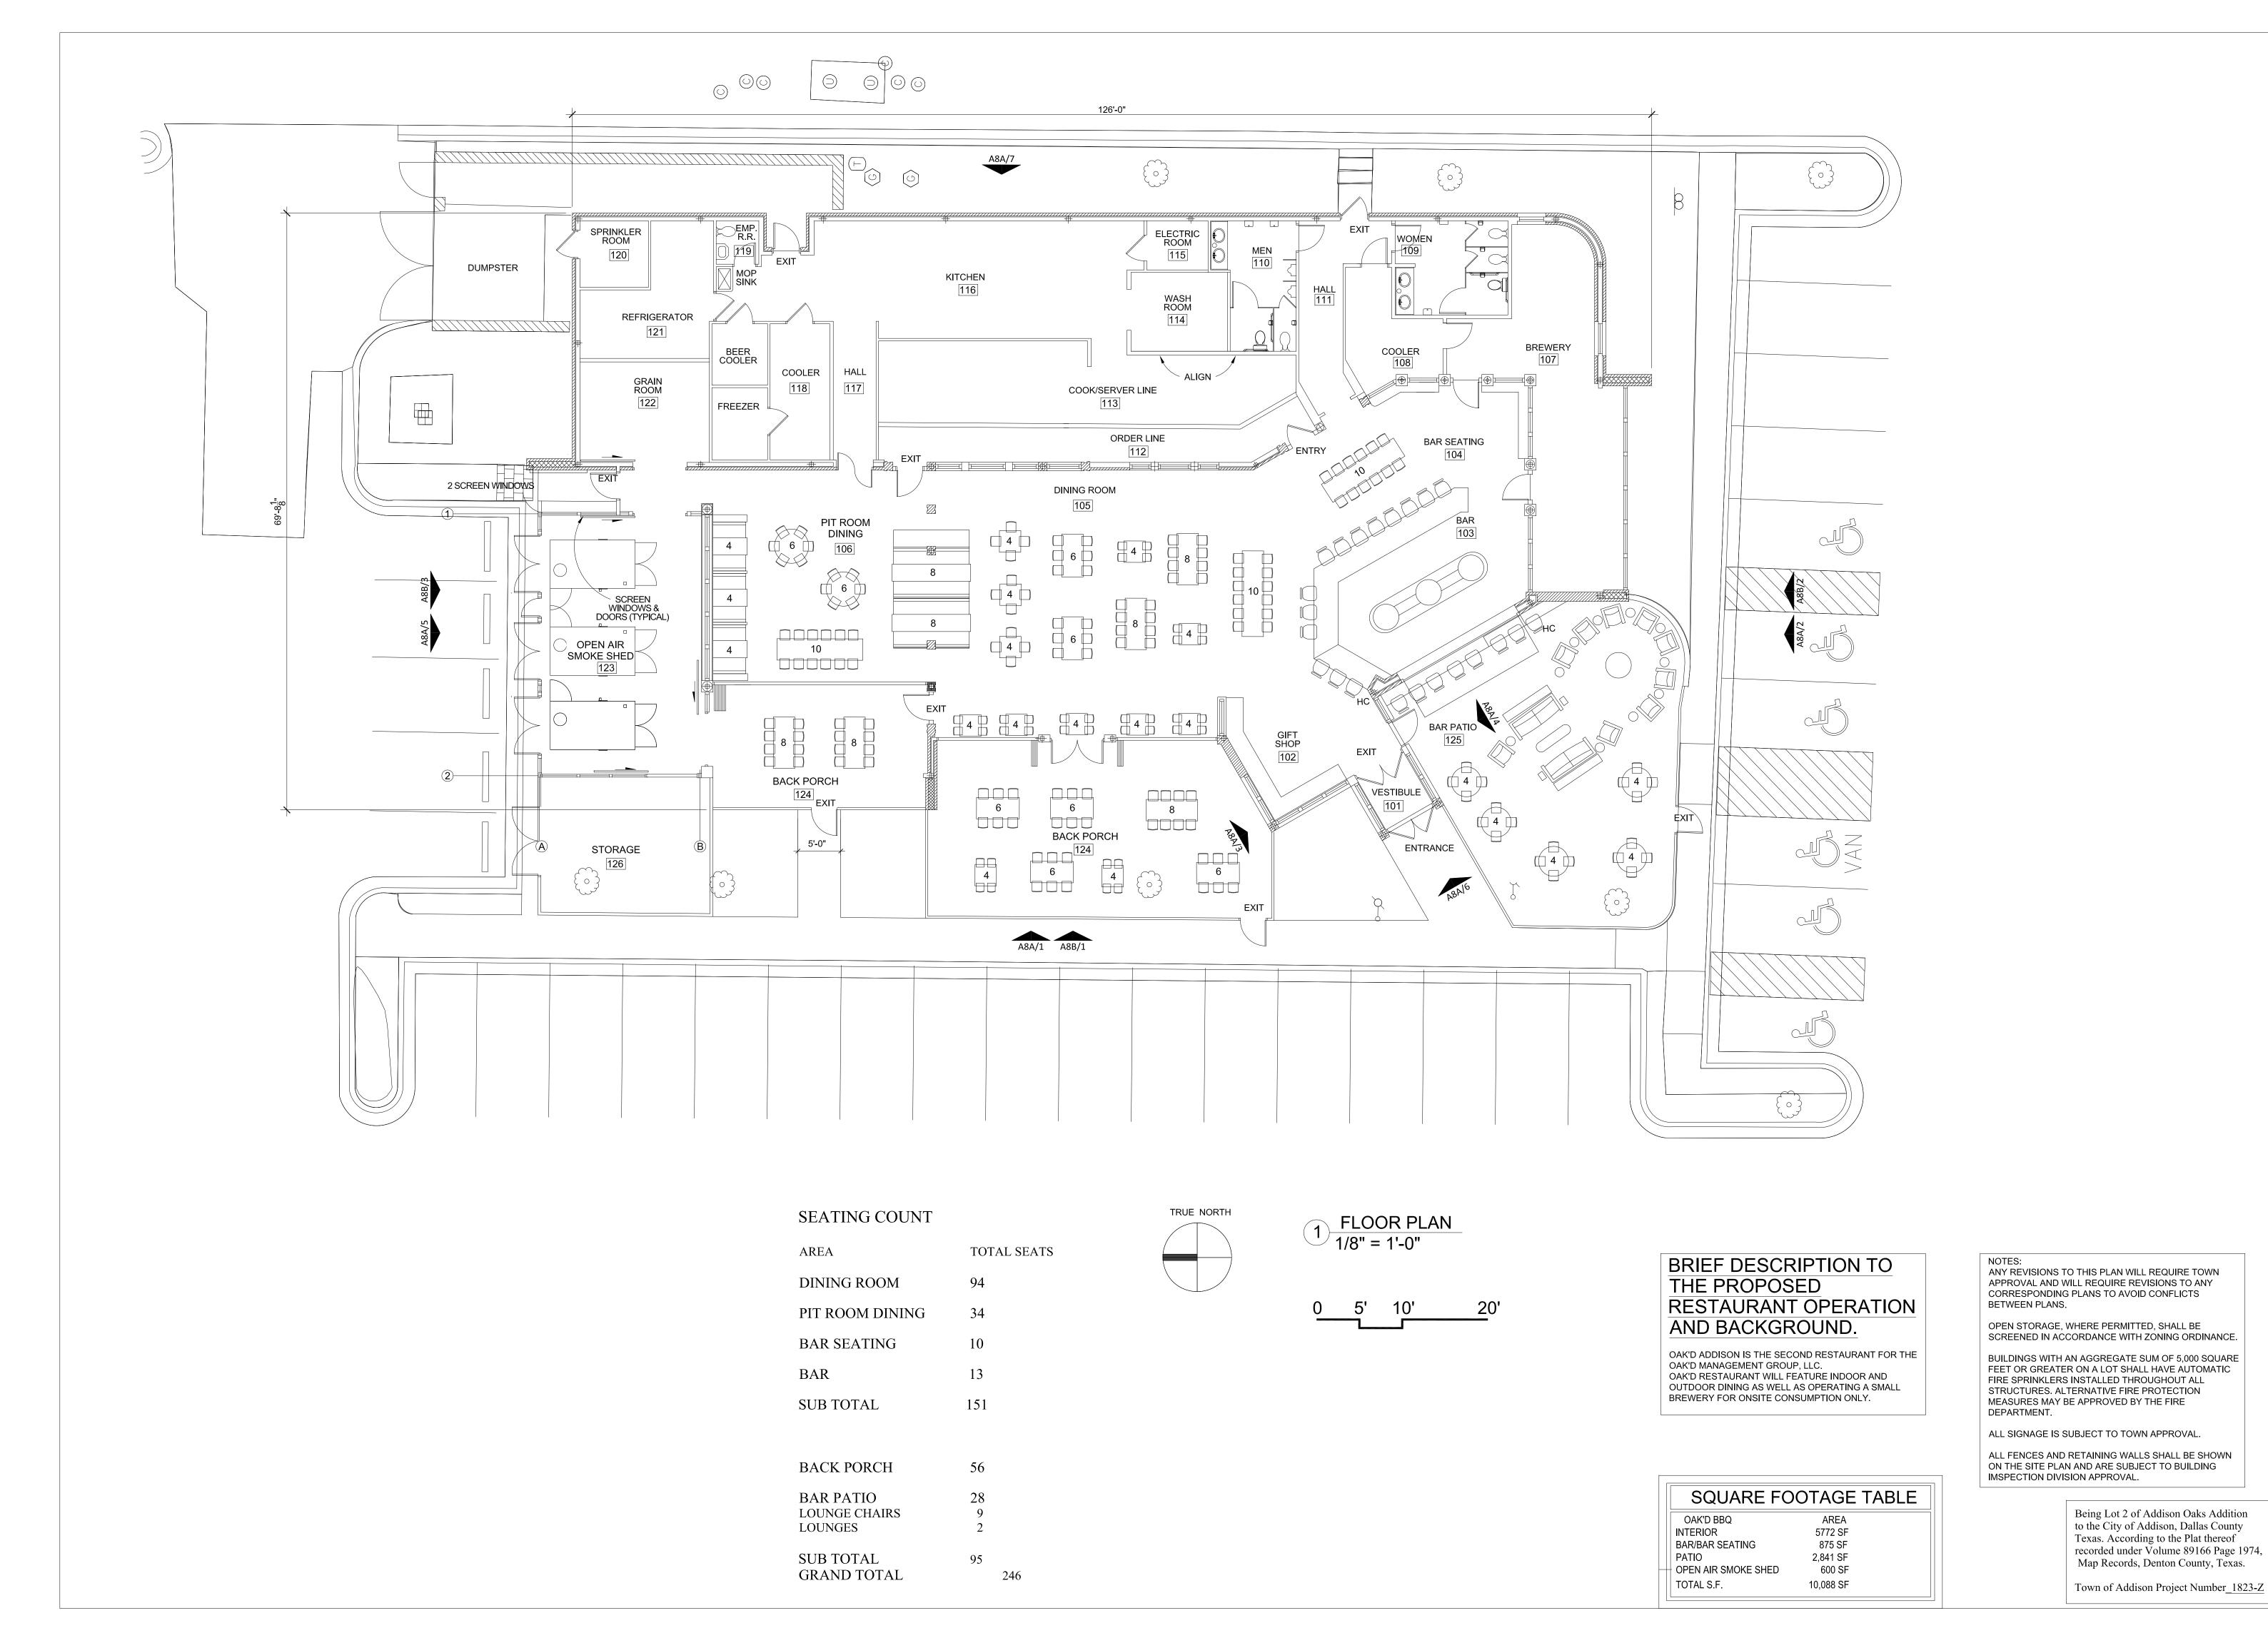

<u>ACTION</u>

APPROVED

See the Staff Approval Letter or Council Result Memo for any conditions associated with the

approval of the project. **ARCHITECT**

KIRK & ASSOCIATES

ARCHITECTURE
INTERIOR DESIGN
P L A N N I N G 5931 GREENVILLE AVE #772 DALLAS, TEXAS 75206 PHONE 214-912-7642 kirkarch1@aol.com www.kirkarchitecture.com

DEVELOPER PROPERTY

OAK'D MANAGEMENT GROUP, LLC CLINT NORTON 5814 Coolwater Cove DALLAS, TEXAS 75252 Cell: 214-546-9999 Email: clint@oakdbbq.com

BARNETT/ADDISON LTD. ELLIOT B. BARNETT 3132 FOREST PARK BLVD. FT. WORTH, TEXAS 75110 Cell: 214-393-3515 Email:

RENOVATION

OAKID

SEAL


REVISIONS					
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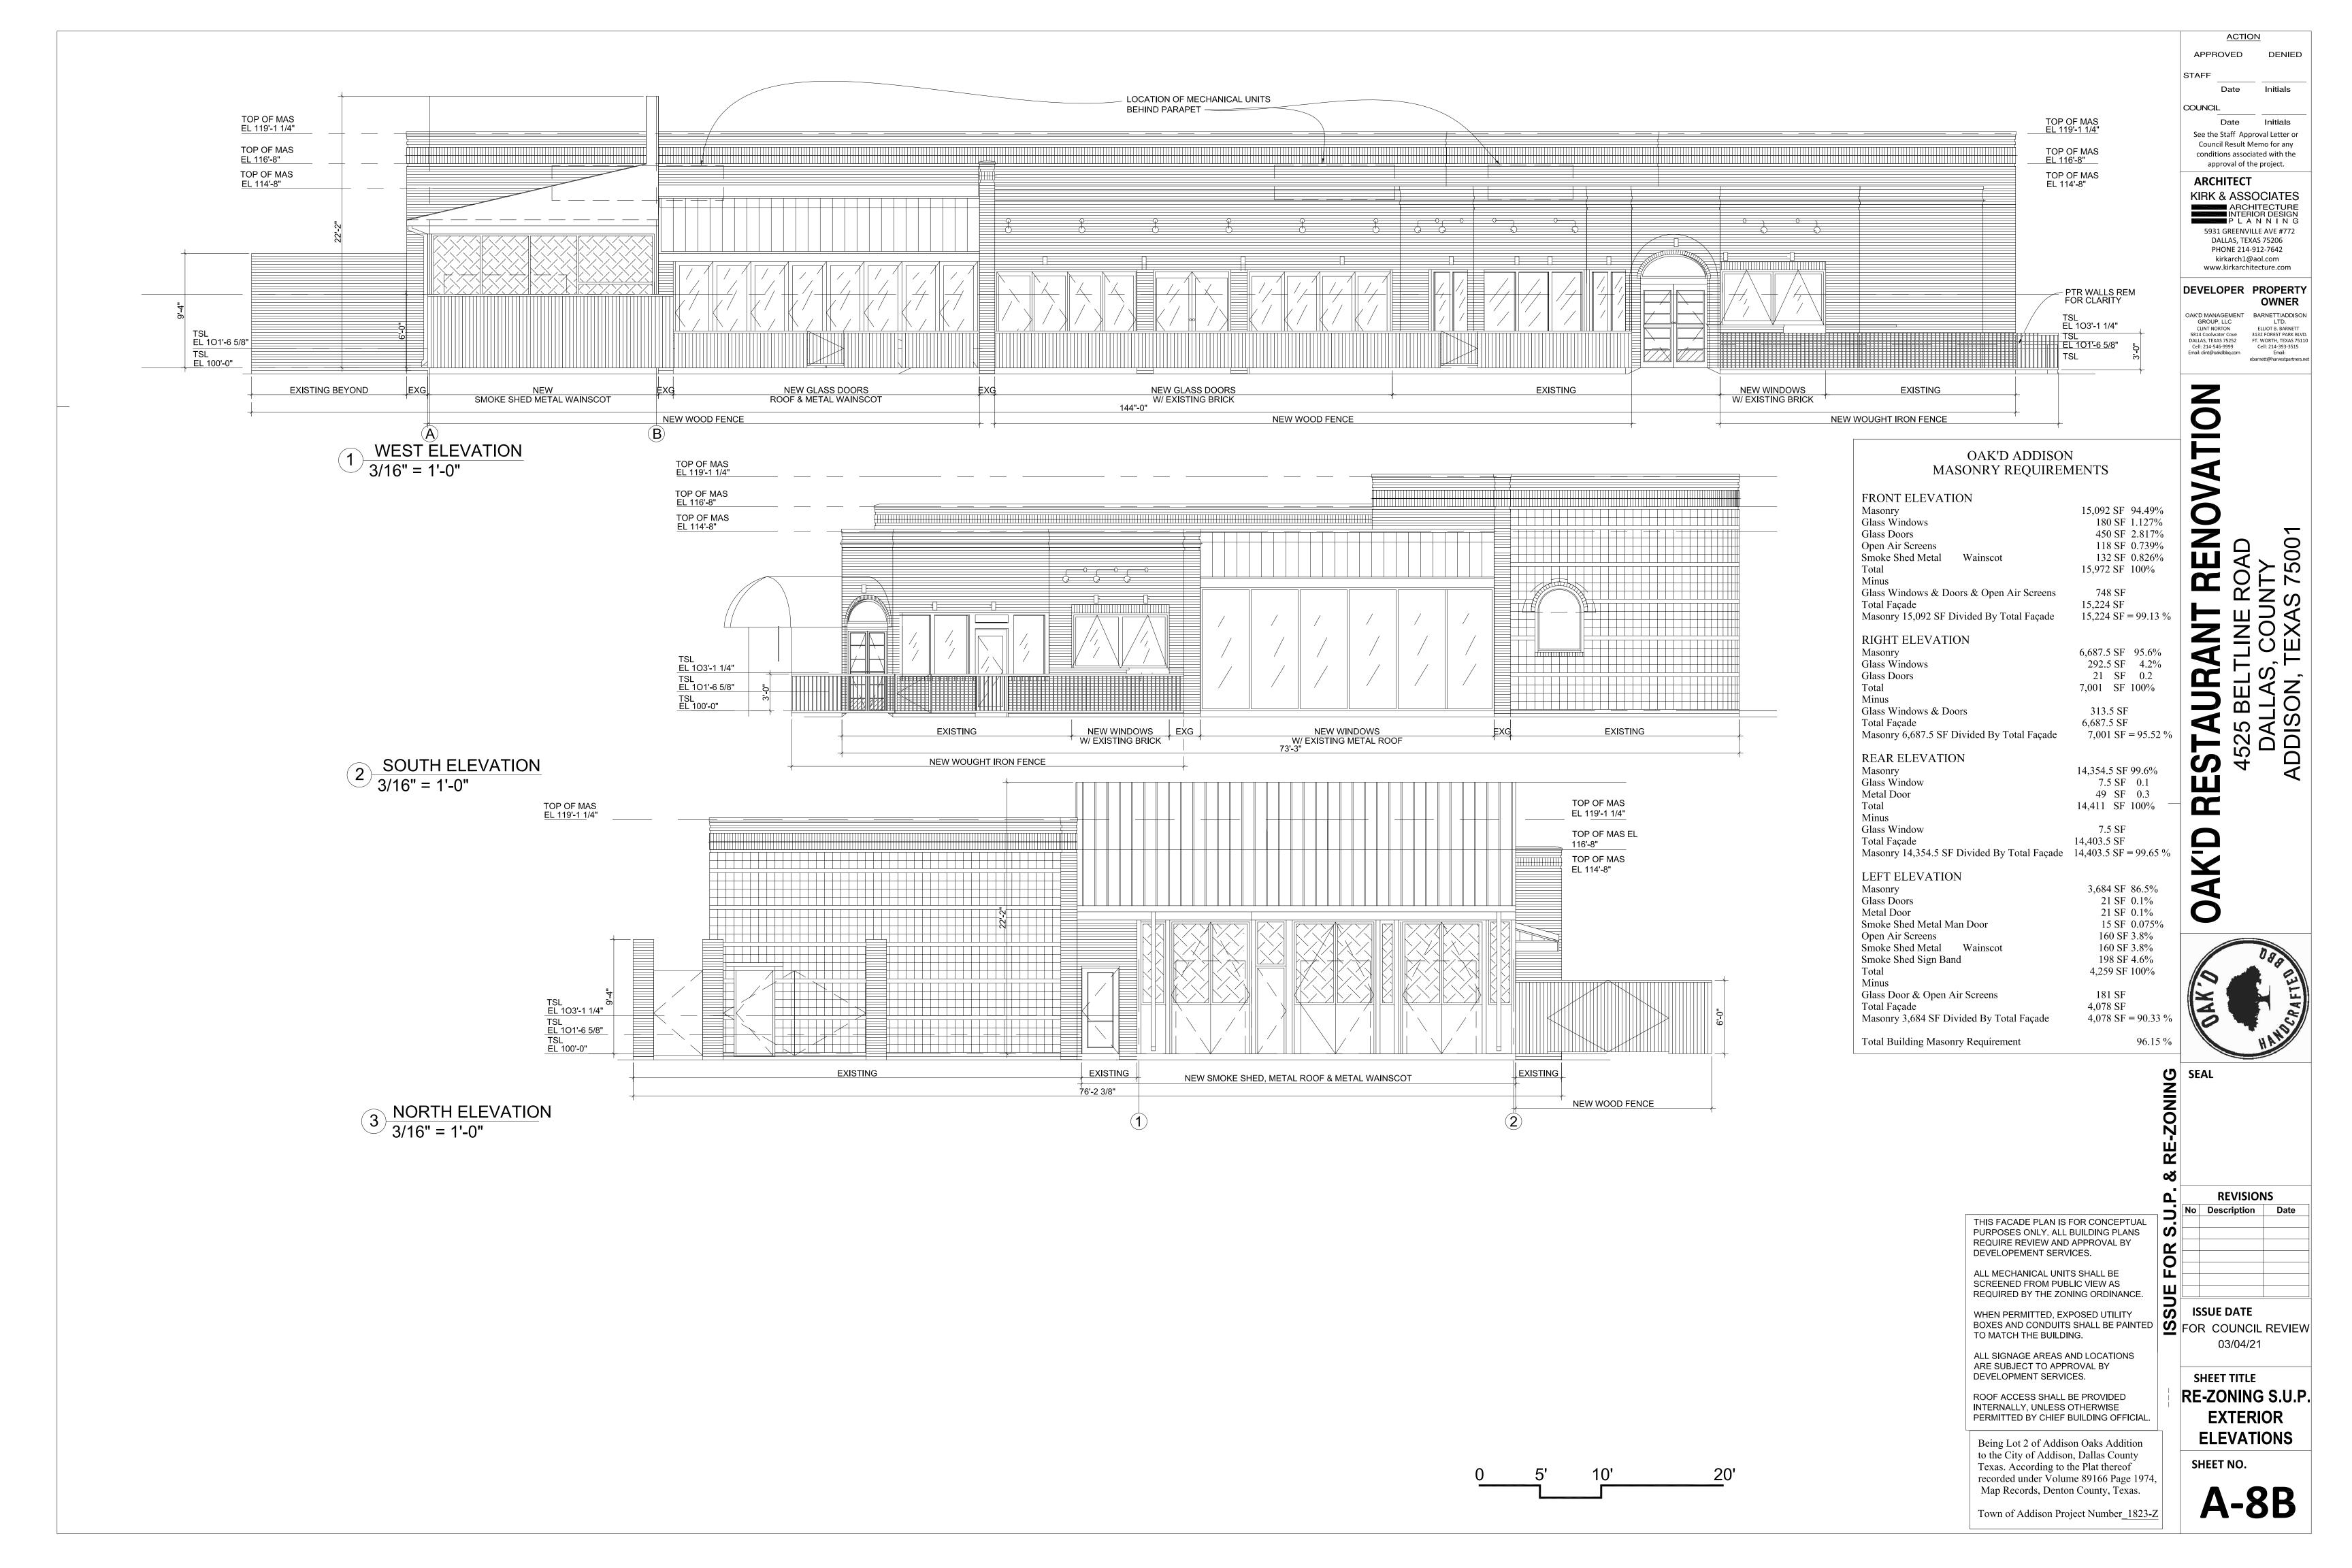
ISSUE DATE FOR COUNCIL REVIEW


03/04/21 SHEET TITLE **RE-ZONING**

S.U.P. **FLOOR PLAN**

SHEET NO.



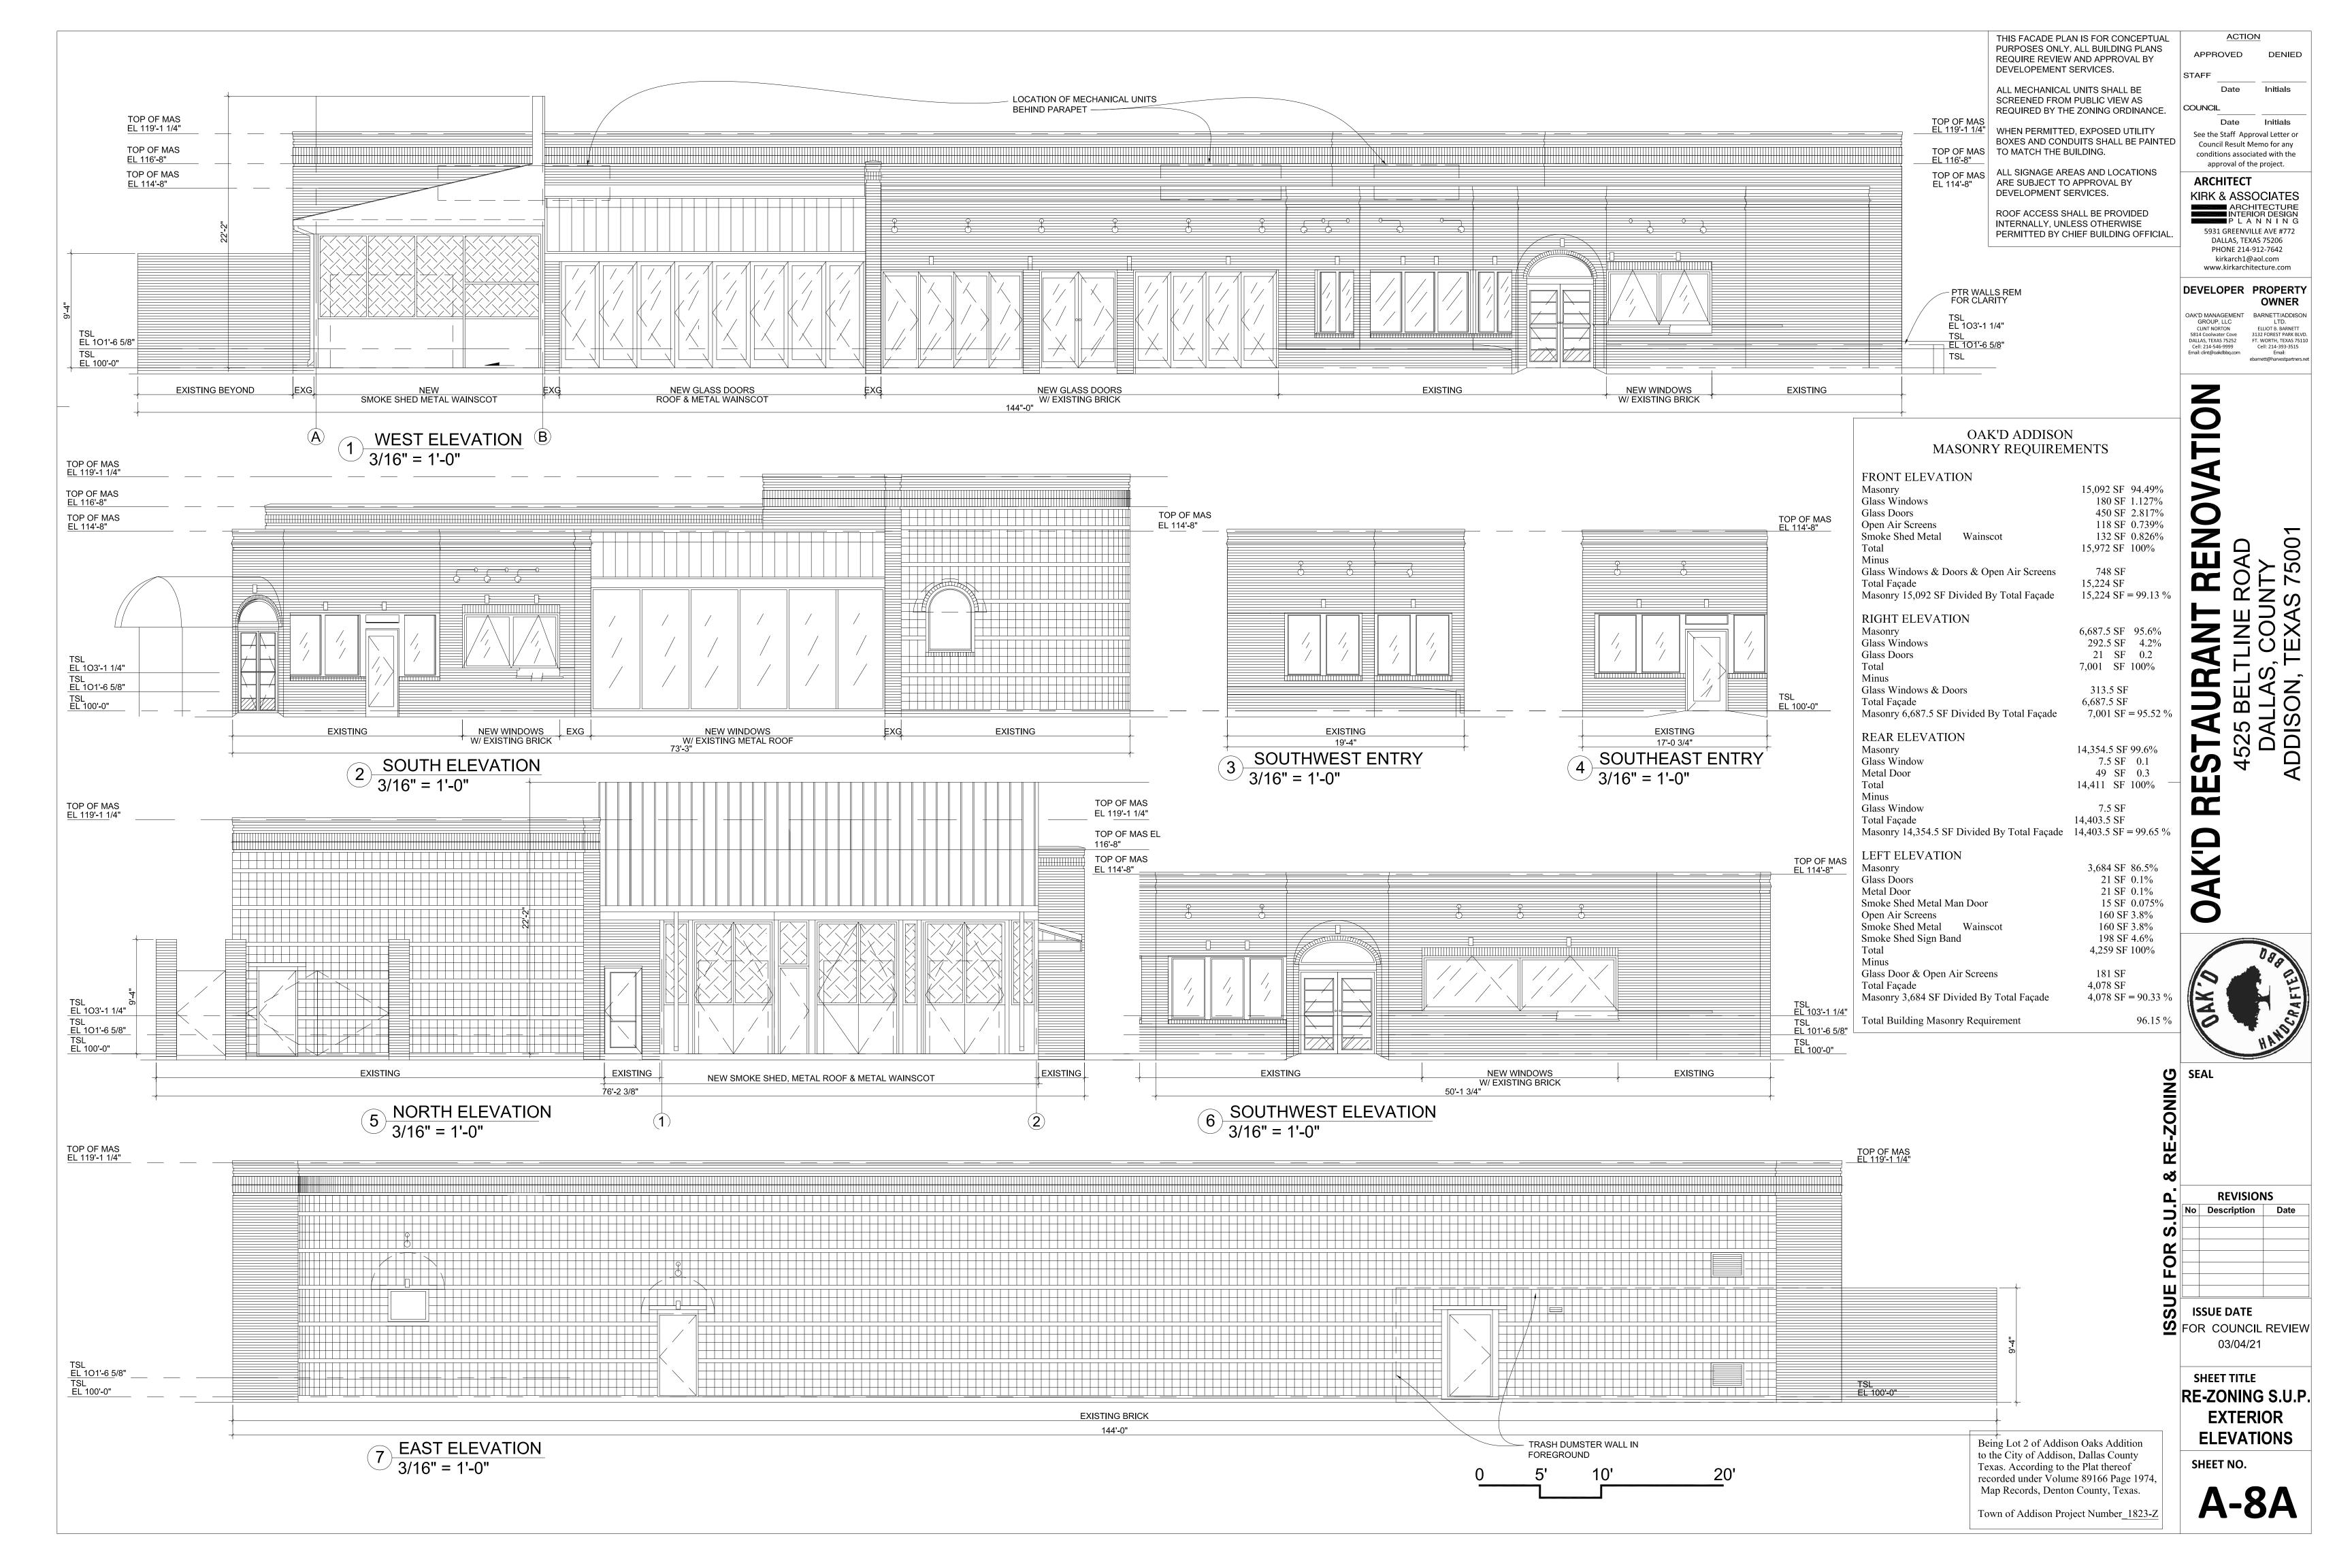

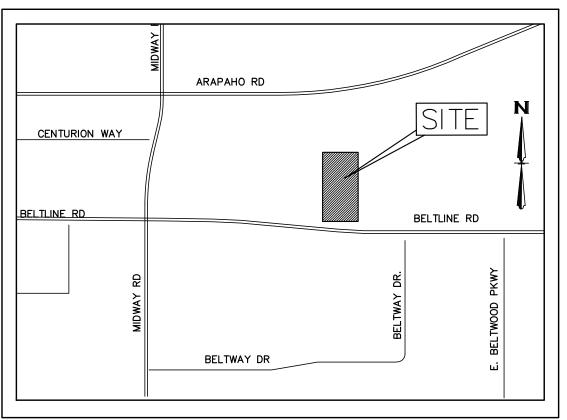

VICINITY MAP

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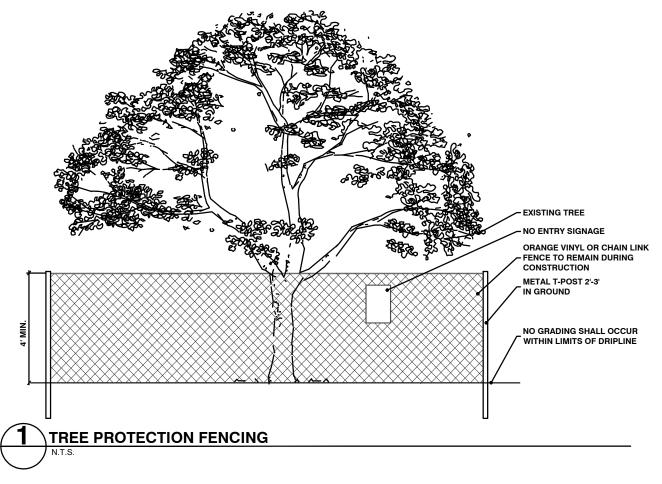
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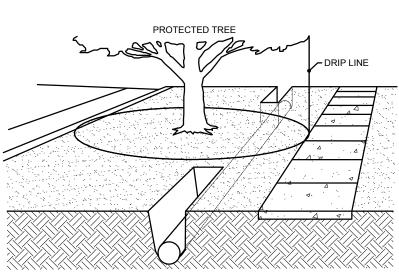
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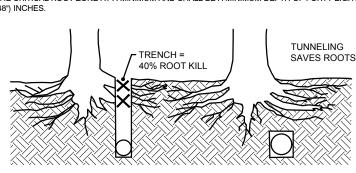
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BORING:
BORING OF UTILITIES UNDER PROTECTED TREES SHALL BE REQUIRED IN CIRCUMSTANCES WHERE IT IS NOT POSSIBLE TO TRENCH AROUND THE CRITICAL ROOT ZONE OF THE PROTECTED TREE. WHERE REQUIRED, THE LENGTH OF THE BORE SHALL BE THE WIDTH OF THE CRITICAL ROOT ZONE AT A MINIMUM AND SHALL BE A MINIMUM DEPTH OF FORTY EIGHT





CALLED 4.7985 ACRES

DOC. NO. 201900146590 O.P.R.D.C.T.

MO COSTO ENERGIA MASEMENTO

EXITING SHRUBS

VOLUME 89166, PAGE 1974 O.P.R.D.C.T.

TO BE REMOVED DUE TO BUILDING

> **EXITING SHRUBS** TO BE REMOVED DUE TO BUILDING

EXISTING ORNAMENTAL

BELT LINE ROAD

REES TO REMAIN

EXISTING ORNAMENTAL

TREES TO BE REMOVED

EXISTING SHRUBS


ARC LENGTH = 193.08

CHORD LENGTH = 193.04

CHORD BEARING N 87°37'37" W

RADIUS = 2814.79'

N 89°22'58" E 193' /

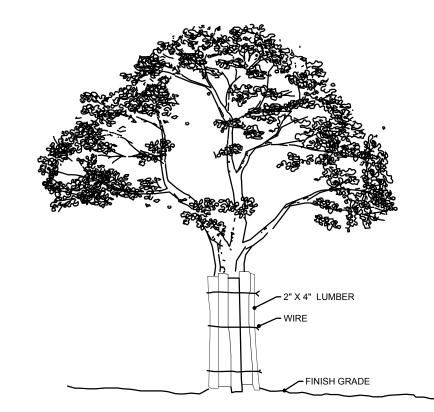

WHERE A PROTECTED TREE REMAINS IN THE IMMEDIATE AREA OF INTENDED CONSTRUCTION, AND THE TREE MAY BE IN DANGER OF BEING DAMAGED BY CONSTRUCTION EQUIPMENT OR OTHER ACTIVITY, THE CONTRACTOR OR SUBCONTRACTOR SHALL PROTECT THE TREE WITH 2° X 4° LUMBER ENCIRCLED WITH WIRE OR OTHER MEANS THAT DO NOT DAMAGE THE BARK OF THE TREE. THE INTENT IS TO PROTECT THE TRUNK OF THE TREE AGAINST INCIDENTAL CONTACT BY LARGE CONSTRUCTION EQUIPMENT.



CRITICAL ROOT ZONE EXCEPT THE MINIMUM REQUIRED SINGLE HEAD SUPPLY LINE. THIS LINE IS ALLOWED TO EXTEND INTO THE CRITICAL ROOT ZONE PERPENDICULAR TO THE TREE TRUNK WITH THE LEAST POSSIBLE TREES TO BE REMOVED: ALL TREES TO BE REMOVED FROM THE SITE SHALL BE kirkarch1@aol.com

FLAGGED BY THE CONTRACTOR WITH BRIGHT RED VINYL TAPE WRAPPED AROUND THE MAIN TRUNK AT A HEIGHT OF FOUR (4') FEET ABOVE GRADE.

BORING: BORING OF UTILITIES UNDER PROTECTED TREES MAY BE REQUIRED.

OF THE CRITICAL ROOT ZONE AND SHALL BE A MINIMUM DEPTH OF FORTY (48)

TRENCHING: ALL TRENCHING SHALL BE DESIGNED TO AVOID TRENCHING

ACROSS CRITICAL ROOT ZONES OF ANY PROTECTED TREE. THE PLACEMENT OF UNDERGROUND UTILITY LINES SUCH AS ELECTRIC, PHONE, GAS, ETC.. IS

ENCOURAGED TO BE LOCATED OUTSIDE THE CRITICAL ROOT ZONE.

TRENCHING FOR IRRIGATION SYSTEMS SHALL BE PLACED OUTSIDE THE

WHEN REQUIRED, THE MINIMUM LENGTH OF THE BORE SHALL BE THE WIDTH

TREES TO REMAIN: ALL TREES TO REMAIN, AS NOTED ON DRAWINGS, SHALL HAVE PROTECTIVE FENCING LOCATED AT THE TREE'S DRIP LINE. THE PROTECTIVE FENCING SHALL BE LOCATED AS INDICATED ON THE TREE PROTECTION DETAIL.

TREE PRESERVATION NOTES

CONSTRUCTION METHODS:

EXISTING TREES NOTED TO REMAIN SHALL BE PROTECTED DURING CONSTRUCTION FROM DAMAGE AND COMPACTION OF SOIL UNDER AND AROUND DRIP LINE OF TREE.

UNDER NO CIRCUMSTANCE SHALL THE CONTRACTOR PRUNE ANY PORTION OF THE DAMAGED TREE WITHOUT THE PRIOR APPROVAL BY THE OWNER'S AUTHORIZED REPRESENTATIVE.

PROHIBITED ACTIVITIES IN CRITICAL ROOT ZONE:
THE FOLLOWING ACTIVITIES ARE PROHIBITED IN THE AREAS NOTED AS THE CRITICAL ROOT ZONE.

MATERIAL STORAGE: NO MATERIALS INTENDED FOR USE IN CONSTRUCTION, OR WASTE MATERIALS ACCUMULATED DUE TO EXCAVATION OR DEMOLITION, SHALL BE PLACED WITHIN THE LIMITS OF THE CRITICAL ROOT ZONE OF ANY PROTECTED TREE.

EQUIPMENT CLEANING/LIQUID DISPOSAL: NO EQUIPMENT SHALL BE CLEANED, OR OTHER LIQUIDS DEPOSITED OR ALLOWED WITHIN THE LIMITS OF THE CRITICAL ROOT ZONE OF A PROTECTED TREE. THIS INCLUDES, WITHOUT LIMITATION: PAINT, OIL, SOLVENTS, ASPHALT, CONCRETE, MORTAR OR SIMILAR

TREE ATTACHMENTS: NO SIGNS, WIRES, OR OTHER ATTACHMENTS, OTHER THAN THOSE OF A PROTECTIVE NATURE, SHALL BE ATTACHED TO ANY

VEHICULAR TRAFFIC: NO VEHICULAR AND/OR CONSTRUCTION, EQUIPMENT, TRAFFIC, OR PARKING SHALL TAKE PLACE WITHIN THE LIMITS OF THE CRITICAL ROOT ZONE OF ANY PROTECTED TREE OTHER THAN ON EXISTING STREET

GRADE CHANGES: A MINIMUM OF 75% OF THE DRIP LINE AND ROOT ZONE SHALL BE PRESERVED AT NATURAL GRADE. ANY FINE GRADING DONE WITHIN THE CRITICAL ROOT ZONES OF THE PROTECTED TREES MUST BE DONE WITH LIGHT MACHINERY SUCH AS A BOBCAT OR LIGHT TRACTOR. NO EARTH MOVING EQUIPMENT WITH TRACKS IS ALLOWED WITHIN THE CRITICAL ROOT ZONE OF

PROCEDURES REQUIRED PRIOR TO CONSTRUCTION:
PROTECTIVE FENCING: PRIOR TO CONSTRUCTION, THE CONTRACTOR OR SUBCONTRACTOR SHALL CONSTRUCT AND MAINTAIN, FOR EACH PROTECTED TREE ON A CONSTRUCTION SITE, A PROTECTIVE FENCING WHICH ENCIRCLES THE OUTER LIMITS OF THE CRITICAL ROOT ZONE OF THE TREE TO PROTECT IT FROM CONSTRUCTION ACTIVITY. ALL PROTECTIVE FENCING SHALL BE IN PLACE PRIOR TO COMMENCEMENT OF ANY SITE WORK, AND REMAIN IN PLACE UNTIL ALL EXTERIOR WORK HAS BEEN COMPLETED.

BARK PROTECTION: IN SITUATIONS WHERE A PROTECTED TREE REMAINS IN THE IMMEDIATE AREA OF INTENDED CONSTRUCTION, AND THE LANDSCAPE ARCHITECT OR OWNERS'S REPRESENTATIVE DETERMINES THE TREE BARK TO BE IN DANGER OF DAMAGE BY CONSTRUCTION EQUIPMENT OR OTHER ACTIVITY, THE CONTRACTOR OR SUBCONTRACTOR SHALL PROTECT THE TREE BY ENCLOSING THE ENTIRE CIRCUMFERENCE OF THE TREE WITH 2"X4" LUMBER ENCIRCLED WITH WIRE OR OTHER MEANS THAT DO NOT DAMAGE THE TREE. THE INTENT IS TO PROTECT THE BARK OF THE TREE AGAINST INCIDENTAL CONTACT BY LARGE CONSTRUCTION EQUIPMENT.


NO.	CALIPER	TREE SPECIES	REMAIN/REMOVE	NOTES
1	14	OAK	TO REMAIN	
2	16	OAK	TO REMAIN	
3	24	OAK	TO REMAIN	
4	15	OAK	TO REMAIN	
5	15	OAK	TO REMAIN	
6	15	OAK	TO REMAIN	
7	24	OAK	TO REMAIN	
8	27	OAK	TO REMAIN	
9	18	OAK	TO REMAIN	
10	12	OAK	TO REMAIN	
11	9	BRADFORD PEAR	TO BE REMOVED	POOR CONDITION
12	10	BRADFORD PEAR	TO BE REMOVED	POOR CONDITION
13	12	BRADFORD PEAR	TO BE REMOVED	POOR CONDITION
14	12	OAK	TO REMAIN	
15	12	OAK	TO REMAIN	
16	12	OAK	TO REMAIN	
17	12	OAK	TO REMAIN	
18	26	OAK	TO REMAIN	
19	18	OAK	TO REMAIN	

TOTAL ON SITE TOTAL TO BE REMOVED

TREE PRESERVATION LEGEND

TREE TO REMAIN

TREE PRESERVATION FENCING

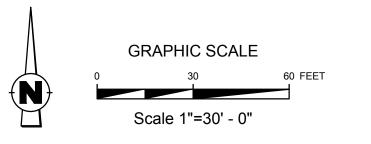



Being Lot 2 of Addison Oaks Addition to the City of Addison, Dallas County Texas. According to the Plat thereof recorded under Volume 89166 Page 1974, Map Records, Denton County, Texas.

Town of Addison Project Number 1823-Z

APPROVED DENIED

Date Initials

COUNCIL

<u>ACTION</u>

Date Initials See the Staff Approval Letter or Council Result Memo for any conditions associated with the approval of the project.

ARCHITECT KIRK & ASSOCIATES


ARCHITECTURE INTERIOR DESIGN P L A N N I N G 5931 GREENVILLE AVE #772 DALLAS, TEXAS 75206 PHONE 214-912-7642

www.kirkarchitecture.com


DEVELOPER PROPERTY OWNER BARNETT/ADDISOI CLINT NORTON

ELLIOT B. BARNETT 3132 FOREST PARK BLVD. FT. WORTH, TEXAS 75110 Cell: 214-393-3515 Email:

Email: clint@oakdbbq.com

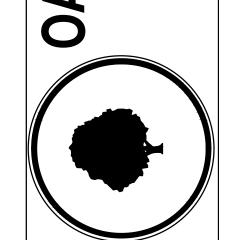

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ISSUE DATE FOR COUNCIL REVIEW 02/26/21

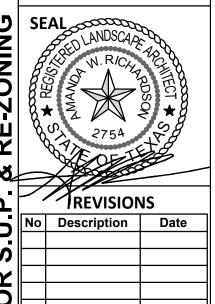SHEET TITLE **TREE**

PRESERVATION PLAN

SHEET NO.

VICINITY MAP

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SITE SU	MMARY
ZONING	PD
PROPOSED USE	RESTAURANT AND BREWERY
BUILDING	
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GENERAL LAWN NOTES

- 1. CONTRACTOR SHALL COORDINATE OPERATIONS AND AVAILABILITY OF EXISTING TOPSOIL WITH ON-SITE CONSTRUCTION MANAGER 2. LAWN AREAS SHALL BE LEFT 1" BELOW FINAL FINISHED GRADE PRIOR
- TO TOPSOIL INSTALLATION. 3. CONTRACTOR TO FIND GRADE AREAS TO ACHIEVE FINAL CONTOURS AS SHOWN ON CIVIL DRAWINGS. POSITIVE DRAINAGE SHALL BE PROVIDED AWAY FROM ALL BUILDINGS. ROUNDING AT TOP AND BOTTOM OF SLOPES SHALL BE PROVIDED AND IN OTHER BREAKS IN
- GRADE. CORRECT AREAS WHERE STANDING WATER MAY OCCUR. 4. ALL LAWN AREAS SHALL BE FINE GRADED, IRRIGATION TRENCHES COMPLETELY SETTLED AND FINISH GRADE APPROVED BY THE OWNER'S CONSTRUCTION MANAGER OR LANDSCAPE ARCHITECT PRIOR TO LAWN
- 5. CONTRACTOR SHALL REMOVE ALL ROCKS 3/4" IN DIAMETER AND LARGER. REMOVE ALL DIRT CLODS, STICKS, CONCRETE SPOILS, TRASH
- ETC PRIOR TO PLACING TOPSOIL AND GRASS INSTALLATION. 6. CONTRACTOR SHALL MAINTAIN ALL LAWN AREAS UNTIL FINAL
- ACCEPTANCE. 7. CONTRACTOR SHALL GUARANTEE ESTABLISHMENT OF ACCEPTABLE TURF AREA AND SHALL PROVIDE REPLACEMENT IF NECESSARY.

SOLID SOD:

1. SOLID SOD SHALL BE PLACED ALONG ALL IMPERVIOUS EDGES, AT A MINIMUM. THIS SHALL INCLUDE CURBS, WALKS, INLETS, MANHOLES AND PLANTING BED AREAS. SOD SHALL COVER OTHER AREAS COMPLETELY AS INDICATED BY PLAN.

- 2. SOD SHALL BE STRONGLY ROOTED DROUGHT RESISTANT SOD, NOT LESS THAN 2 YEARS OLD, FREE OF WEEDS AND UNDESIRABLE NATIVE GRASS AND MACHINE CUT TO PAD THICKNESS OF 3/4" (+1/4"),
- EXCLUDING TOP GROWTH AND THATCH. 3. LAY SOD BY HAND TO COVER INDICATED AREAS COMPLETELY, ENSURING EDGES ARE TOUCHING WITH TIGHTLY FITTING JOINTS, NO
- OVERLAPS WITH STAGGERED STRIPS TO OFFSET JOINTS. 4. TOP DRESS JOINTS IN SOD BY HAND WITH TOPSOIL TO FILL VOIDS IF
- 5. SOD SHALL BE ROLLED TO CREATE A SMOOTH EVEN SURFACE, SOD SHOULD BE WATERED THOROUGHLY DURING INSTALLATION PROCESS.
- 6. SHOULD INSTALLATION OCCUR BETWEEN OCTOBER 1ST AND MARCH 1ST, OVERSEED BERMUDAGRASS SOD WITH WINTER RYEGRASS AT A RATE OF 4 POUNDS PER 1000 S.F.

- 1. SCARIFY AND LOOSEN ALL AREAS TO BE HYDROMULCHED TO A MINIMUM DEPTH OF 4" PRIOR TO TOPSOIL AND HYDROMULCH
- 2. BERMUDA GRASS SEED SHALL BE EXTRA HULLED, TREATED LAWN TYPE. SEED SHALL BE DELIVERED TO THE SITE IN ITS ORIGINAL UNOPENED CONTAINER AND SHALL MEET ALL STATE/LOCAL LAW REQUIREMENTS
- 3. FIBER SHALL BE 100% WOOD CELLULOSE FIVER, DELIVERED TO THE SITE IN ITS ORIGINAL UNOPENED CONTAINER AS MANUFACTURED BY
- "CONWEB' OR EQUAL 4. FIBER TACK SHALL BE DELIVERED TO THE SITE IN ITS UNOPENED CONTAINER AND SHALL BE 'TERRO-TACK ONE', AS MANUFACTURED
- BY GROWERS, INC OR APPROVED EQUAL 5. HYDROMULCH WITH BERMUDA GRASS SEET AT A RATE OF 2 POUNDS
- 6. USE A BATTER BOARD AGAINST ALL BED AREAS TO PREVENT OVER
- 7. IF INADEQUATE MOISTURE IS PRESENT IN SOIL, APPLY WATER AS
- NECESSARY FOR OPTIMUM MOISTURE FOR SEED APPLICATION. IF INSTALLATION OCCURS BETWEEN SEPTEMBER 1ST AND MAY 1ST, ALL HYDORMULCH AREAS SHALL BE OVER-SEEDED WITH WINTER
- RYE GRASS AT A RATE OF FOUR POUNDS PER ONE THOUSAND SQUARE FEET. CONTRACTOR SHALL BE REQUIRED TO RE-HYDROMULCH WITH BERMUDA GRASS THE FOLLOWING GROWING SEASON AS PART OF THIS CONTRACT.

LANDSCAPE NOTES

- CONTRACTOR TO VERIFY AND LOCATE ALL PROPOSED AND EXISTING ELEMENTS. NOTIFY LANDSCAPE ARCHITECT OR DESIGNATED REPRESENTATIVE FOR ANY LAYOUT DISCREPANCIES OR ANY CONDITION THAT WOULD PROHIBIT THE INSTALLATION AS SHOWN. SURVEY DATA OF
- EXISTING CONDITIONS WAS SUPPLIED BY OTHERS 2. CONTRACTOR SHALL CALL 811 TO VERIFY AND LOCATE ANY AND ALL UTILITIES ON SITE PRIOR TO COMMENCING WORK. LANDSCAPE ARCHITECT SHOULD BE NOTIFIED OF ANY CONFLICTS. CONTRACTOR TO
- UTILITIES. 3. A MINIMUM OF 2% SLOPE SHALL BE PROVIDED AWAY FROM ALL
- STRUCTURES. 4. CONTRACTOR SHALL FINE GRADE AREAS TO ACHIEVE FINAL CONTOURS AS INDICATED. LEAVE AREAS TO RECEIVE TOPSOIL 3" BELOW FINAL FINISHED GRADE IN PLANTING AREAS AND 1" BELOW FINAL FINISHED

EXERCISE EXTREME CAUTION WHEN WORKING NEAR UNDERGROUND

- GRADE IN LAWN AREAS. 5. LANDSCAPE ISLANDS SHALL BE CROWNED, AND UNIFORM THROUGHOUT THE SITE.
- 6. PLANTING AREAS AND SOD TO BE SEPARATED BY STEEL EDGING. NO STEEL EDGING SHALL BE INSTALLED ADJACENT TO BUILDINGS, WALKS OR CURBS. EDGING NOT TO BE MORE THAN 1/2" ABOVE FINISHED GRADE.
- 7. EDGING SHALL BE CUT AT 45 DEGREE ANGLE WHERE IT INTERSECTS WALKS AND/OR CURBS.
- 8. MULCH SHALL BE INSTALLED AT 1/2" BELOW THE TOPS OF SIDEWALKS AND CURBING.
- 9. QUANTITIES ON THESE PLANS ARE FOR REFERENCE ONLY. THE SPACING OF PLANTS SHOULD BE AS INDICATED ON PLANS OR OTHERWISE NOTED. ALL TREES AND SHRUBS SHALL BE PLANTED PER DETAILS. 10. CONTAINER GROWN PLANT MATERIAL IS PREFERRED HOWEVER BALL AND BURLAP PLANT MATERIAL CAN BE SUBSTITUTED IF NEED BE AND IS

APPROPRIATE TO THE SIZE AND QUALITY INDICATED ON THE PLANT

- MATERIAL LIST. 11. TREES SHALL BE PLANTED AT A MINIMUM OF 5' FROM ANY UTILITY LINE, SIDEWALK OR CURB. TREES SHALL ALSO BE 10' CLEAR FROM FIRE
- 12. 4" OF SHREDDED HARDWOOD MULCH (2" SETTLED THICKNESS) SHALL BE PLACED OVER WEED BARRIER FABRIC. MULCH SHALL BE SHREDDED HARDWOOD MULCH OR APPROVED EQUAL, PINE STRAW MULCH IS
- PROHIBITED. 13. WEED BARRIER FABRIC SHALL BE USED IN PLANT BEDS AND AROUND ALL TREES AND SHALL BE MIRAFI 1405 WEED BARRIER OR APPROVED EQUAL. 14. CONTRACTOR TO PROVIDE UNIT PRICING OF LANDSCAPE MATERIALS

AND BE RESPONSIBLE FOR OBTAINING ALL LANDSCAPE AND IRRIGATION

1. ALL REQUIRED LANDSCAPE AREAS SHALL HAVE AN AUTOMATIC IRRIGATION SYSTEM WITH A FREEZE/RAIN SENSOR. SYSTEM SHALL ALSO HAVE AN ET WEATHER BASED CONTROLLER AND BE DESIGNED AND INSTALLED BY A LICENSED IRRIGATOR.

VEGETATION SHOULD BE INSPECTED REGULARLY TO ENSURE THAT PLANT MATERIAL IS ESTABLISHING PROPERLY AND REMAINS IN A HEALTHY GROWING CONDITION APPROPRIATE FOR THE SEASON. IF DAMAGED OR REMOVED, PLANTS MUST BE REPLACED BY A SIMILAR

- 2. MOWING, TRIMMING, EDGING AND SUPERVISION OF WATER APPLICATIONS SHALL BE THE RESPONSIBILITY OF THE CONTRACTOR UNTIL THE OWNER OR OWNER'S REPRESENTATIVE ACCEPTS AND ASSUMES REGULAR MAINTENANCE.
- 3. ALL LANDSCAPE AREAS SHOULD BE CLEANED AND KEPT FREE OF TRASH, DEBRIS, WEEDS AND OTHER MATERIAL.

STEEL EDGING SHALL BE 3/16" X 4 X 16' DARK GREEN DURAEDGE STEEL LANDSCAPE EDGING UNLESS NOTED OTHERWISE ON

2. DECOMPOSED GRANITE SHALL CONSIST OF A NATURAL MIX OF GRANITE AGGREGATE NOT TO EXCEED 1/8" IN DIAMETER AND COMPOSED OF VARIOUS STAGES OF DECOMPOSED EARTH BASE. DG SHALL BE PLACED OVER FILTER FABRIC AT A MINIMUM OF 3" DEPTH.

LANDSCAPE TABULATIONS for ADDISON, TEXAS

SITE LANDSCAPE 1. 20% of the total site are to be landscaped Total Site Area: 76,286 s.f. REQUIRED PROVIDED previous s.f. (9,583 s.f.) 15,257 s.f. (20%)

STREET LANDSCAPE BUFFER 1. A 20' landscape buffer is required along public street 2. 1 shade tree, 4 inches in caliper, is required per ever 30 linear feet of street frontage (no tree shall be within 36" of paved parking

current s.f. (10.062 s.f.)

3. Evergreen shrubs shall be planted 3 to 3.5' on center depending on species

Belt Line Road Frontage - 193 l.f.

REQUIRED PROVIDED 20' buffer 20' buffer 6 shade trees, 4" cal. 6 shade trees, 4" cal.

16 existing shrubs; 43 proposed 55 shrubs shrubs PARKING LOT SCREENING

1. Screening must be provided for all surface parking lots from

adjacent roadways. REQUIRED PROVIDED screening

PARKING LOT PERIMETER LANDSCAPE 1. 5' wide landscape strip shall be provided 2. One 4" cal. Tree shall be provided for each 35 l.f. of perimeter

and one shrub planted for every 3-3.5' on center. Perimeter: 389 I.f.

REQUIRED 5' buffer 11 shade trees, 4" cal.

9 proposed shade trees, 4" cal.; 2 existing trees 70 existing shrubs, 41 proposed 111 shrubs

PROVIDED

3' buffer

PARKING LOT INTERIOR LANDSCAPE

1. 5% of the interior parking lot to be landscaped.

2. One shade tree for each 10 spaces. Parking area: 40,612 s.f. Parking Spaces: 154

REQUIRED PROVIDED 2,030 s.f. (5%) 2,683 (6.6%)

7 existing trees; 9 proposed 15 shade trees, 4" cal. trees, 4" cal.

PLAN Being Lot 2 of Addison Oaks Addition to the City of Addison, Dallas County SHEET NO.

<u>ACTION</u>

DENIED

Initials

Initials

APPROVED

COUNCIL

Date

Date

ARCHITECT

See the Staff Approval Letter or

Council Result Memo for any

conditions associated with the

approval of the project.

KIRK & ASSOCIATES

ARCHITECTURE

5931 GREENVILLE AVE #772

DALLAS, TEXAS 75206

PHONE 214-912-7642

kirkarch1@aol.com

DEVELOPER PROPERTY

CLINT NORTON

Email: clint@oakdbbq.com

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AKID

O

(D) SEAL

REVISIONS

ISSUE DATE

9 FOR COUNCIL REVIEW

02/26/21

LANDSCAPE

SHEET TITLE

Description Date

OWNER


ELLIOT B. BARNET

3132 FOREST PARK BLV

FT. WORTH, TEXAS 75110 Cell: 214-393-3515 Email:

www.kirkarchitecture.com

INTERIOR DESIGN P L A N N I N G

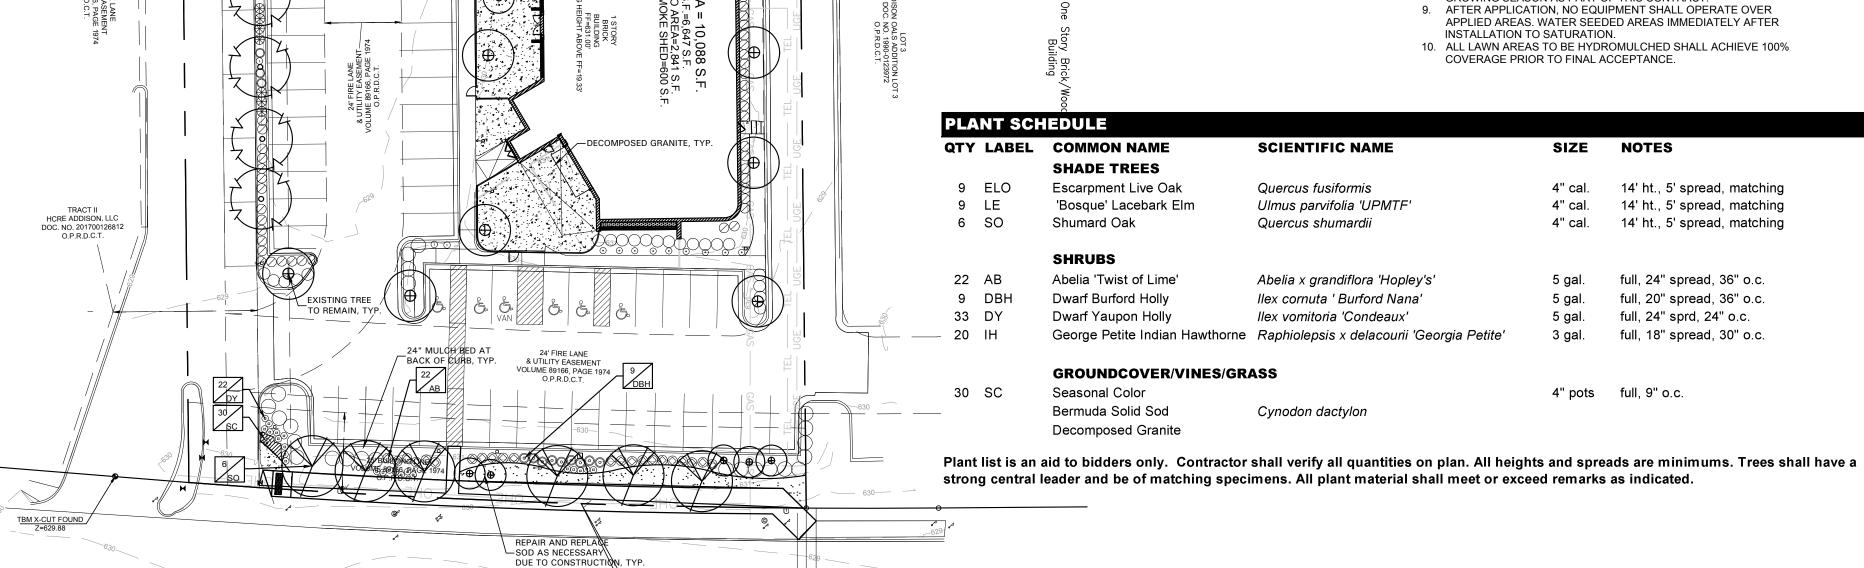

ARC LENGTH = 193.08

CHORD LENGTH = 193.04

CHORD BEARING N 87°37'37" W

RADIUS = 2814.79'


BELT LINE ROAD

100' R.O.W.

CALLED 4.7985 ACRES


TO VAN GIOTO EDECTRIA NA SEMENDO

N 89°22'58" E 193'

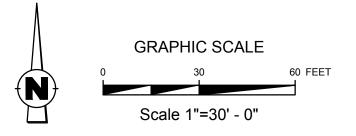





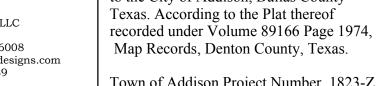

Town of Addison Project Number 1823-Z

PART 1 - GENERAL

1.1 QUALIFICATIONS OF THE LANDSCAPE CONTRACTOR.

- A. ALL LANDSCAPE WORK SHOWN ON THESE PLANS SHALL BE PERFORMED BY A SINGLE FIRM SPECIALIZING IN LANDSCAPE PLANTING
- A. REFER TO LANDSCAPE PLANS, NOTES, SCHEDULES AND DETAILS FOR
- ADDITIONAL REQUIREMENTS
- 1.3 SCOPE OF WORK / DESCRIPTION OF WORK A. WORK COVERED BY THESE SECTIONS INCLUDES: FURNISH ALL SUPERVISIONS, LABOR, MATERIALS, SERVICES, EQUIPMENT AND APPLIANCES REQUIRED TO COMPLETE THE WORK COVERED CONJUNCTION WITH THE LANDSCAPING COVERED IN LANDSCAPE PLANS
 - AND SPECIFICATIONS INCLUDING: PLANTING (TREES, SHRUBS, GRASSES)
 - BED PREP AND FERTILIZATION 3. NOTIFICATION OF SOURCES
 - 4. WATER AND MAINTENANCE UNTIL ACCEPTANCE
- B. ALL WORK SHALL BE PERFORMED IN ACCORDANCE WITH ALL APPLICABLE LAWS, CODES AND REGULATIONS REQUIRED BY AUTHORITIES HAVING JURISDICTION OVER SUCH WORK, INCLUDING ALL INSPECTIONS AND PERMITS REQUIRED BY FEDERAL, STATE AND LOCAL AUTHORITIES IN SUPPLY, TRANSPORTATION AND INSTALLATION OF MATERIALS.
- C. THE LANDSCAPE CONTRACTOR SHALL VERIFY THE LOCATION OF ALL UNDERGROUND UTILITY LINES (WATER, SEWER, ELECTRICAL, TELEPHONE GAS, CABLE, TELEVISION, ETC.) PRIOR TO THE START OF ANY WORK
- A AMERICAN STANDARD FOR NURSERY STOCK PUBLISHED BY AMERICAN ASSOCIATION OF NURSERYMEN; 27 OCTOBER 1980, EDITION; BY AMERICAN
- NATIONAL STANDARDS INSTUTUTE (Z60.1) PLANT MATERIAL B. AMERICAN JOINT COMMITTEE ON HORTICULTURE NOMENCLATURE; 1942 EDITION OF STANDARDIZED PLANT NAMES.
- C. TEXAS ASSOCIATION OF NURSERYMEN, GRADES AND STANDARDS
- A PROVIDE REPRESENTATIVE QUANTITIES OF FACH SOIL MULICH BED MIX GRAVEL AND STONE BEFORE INSTALLATION. SAMPLES TO BE APPROVED BY
- OWNER'S REPRESENTATIVE BEFORE USE. B. SOIL AMENDMENTS AND FERTILIZERS SHOULD BE RESEARCHED AND BASED ON THE SOILS IN THE AREA. C. BEFORE INSTALLATION, SUBMIT DOCUMENTATION THAT PLANT MATERIALS
- ARE AVAILABLE AND HAVE BEEN RESERVED. FOR ANY PLANT MATERIAL NOT AVAILABLE, SUBMIT REQUEST FOR SUBSTITUTION.
- 1.6 JOB CONDITIONS, DELIVERY, STORAGE AND HANDLING A. GENERAL CONTRACTOR TO COMPLETE WORK BEFORE LANDSCAPE
- CONTRACTOR TO COMMENCE. B. ALL PLANTING BED AREAS SHALL BE LEFT THREE INCHES BELOW FINAL GRADE OF SIDEWALKS. DRIVES AND CURBS. ALL AREAS TO RECEIVE SOLID SOD SHALL BE LEFT ONE INCH BELOW THE FINAL GRADE OF WALKS, DRIVES AND CURBS. CONSTRUCTION DEBRIS SHALL BE REMOVED PRIOR TO
- ANDSCAPE CONTRACTOR BEGINNING WORK C. STORAGE OF MATERIALS AND EQUIPMENT AT THE JOB SITE WILL BE AT THE RISK OF THE LANDSCAPE CONTRACTOR. THE OWNER CANNOT BE HELD RESPONSIBLE FOR THEFT OR DAMAGE.

- A. INSTALL TREES, SHRUBS, AND LINER STOCK PLANT MATERIALS PRIOR TO INSTALLATION OF LAWN/SOLID SOD.
- B. WHERE EXISTING TURF AREAS ARE BEING CONVERTED TO PLANTING BEDS THE TURF SHALL BE CHEMICALLY ERADICATED TO MINIMIZE RE-GROWTH IN THE FUTURE. AREAS SHALL BE PROPERLY PREPARED WITH AMENDED ORGANIC MATTER.

1.8 MAINTENANCE AND GUARANTEE

- A. THE LANDSCAPE CONTRACTOR SHALL BE HELD RESPONSIBLE FOR THE MAINTENANCE OF ALL WORK FROM THE TIME OF PLANTING UNTIL FINAL ACCEPTANCE BY OWNER.
- B. NO TREES, GRASS, GROUNDCOVER OR GRASS WILL BE ACCEPTED UNLESS THEY SHOW HEALTHY GROWTH AND SATISFACTORY FOLIAGE CONDITIONS.
- C. MAINTENANCE SHALL INCLUDE WATERING OF TREES AND PLANTS CULTIVATION, WEED SPRAYING, EDGING, PRUNING OF TREES, MOWING OF GRASS, CLEANING UP AND ALL OTHER WORK NECESSARY FOR MAINTENANCE.

SEE DETAIL A

SET TREE IN PLANTING PIT

PLACE ANCHOR WITH RING SIDE DOWN AGAINST TOP OF ROOT

ALIGN DRIVE ROD AS CLOSE AS POSSIBLE TO OUTSIDE EDGE OF

\TREE PLANTING

- D. A WRITTEN NOTICE REQUESTING FINAL INSPECTION AND ACCEPTANCE SHOULD BE SUBMITTED TO THE OWNER AT LEAST 7 DAYS PRIOR TO COMPLETION. AN ON SITE INSPECTION BY THE OWNER'S AUTHORIZED REPRESENTATIVE WILL BE COMPLETED PRIOR TO WRITTEN ACCEPTANCE.
- E. NOTIFY OWNER OR OWNER'S REPRESENTATIVE SEVEN DAYS PRIOR TO THE EXPIRATION OF THE WARRANTY PERIOD. F. REMOVE DEAD, UNHEALTHY AND UNSIGHTLY PLANTS DURING WARRANTY

FERTILIZE, WEED AND APPLY HERBICIDES AND FUNGICIDES AS REQUIRED.

- G. REMOVE GUYING AND STAKING MATERIALS AFTER ONE YEAR
- H. ALL LANDSCAPE MUST BE MAINTAINED AND GRASS MOWED/EDGED ON A WEEKLY SCHEDULE UNTIL ACCEPTANCE BY OWNER. REMOVE CLIPPINGS AND DEBRIS FROM SITE PROMPTLY. REMOVE TRASH, DEBRIS, AND LITTER. WATER, PRUNE, RESTAKE TREES,
- .I COORDINATE THE OPERATION OF IRRIGATION SYSTEM TO ENSURE THAT PLANTS ARE ADEQUATELY WATERED. HAND WATER AREAS NOT RECEIVING ADEQUATE WATER FROM AN IRRIGATION SYSTEM. K. THE LANDSCAPE CONTRACTOR SHALL MAINTAIN THE IRRIGATION SYSTEM IN ACCORDANCE TO THE MAINTENANCE SERVICE TO ENSURE THE SYSTEM IS
- IN PROPER WORKING ORDER WITH SCHEDULING ADJUSTMENTS BY SEASON TO MAXIMIZE WATER CONSERVATION. L. REAPPLY MULCH TO BARE AND THIN AREAS. M. SHOULD SEEDED AND/OR SODDED AREAS NOT BE COVERED BY AN
- AUTOMATIC IRRIGATION SYSTEM, THE LANDSCAPE CONTRACTOR SHALL BE RESPONSIBLE FOR WATERING THESE AREAS AND OBTAINING A FULL, HEALTHY STAND OF GRASS AT NO ADDITIONAL COST TO THE OWNER. N. TO ACHIEVE FINAL ACCEPTANCE AT THE END OF THE MAINTENANCE PERIOD, ALL OF THE FOLLOWING CONDITIONS MUST OCCUR:
 - a. THE LANDSCAPE SHALL SHOW ACTIVE, HEALTHY GROWTH (WITH EXCEPTIONS MADE FOR SEASONAL DORMANCY). ALL PLANTS NOT MEETING THIS CONDITION SHALL BE REJECTED AND REPLACED BY
 - HEALTHY PLANT MATERIAL PRIOR TO FINAL ACCEPTANCE. b. ALL HARDSCAPE SHALL BE CLEANED PRIOR TO FINAL ACCEPTANCE.
 - c. SODDED AREAS MUST BE ACTIVELY GROWING AND MUST REACH A MINIMUM HEIGHT OF 1 1/2 INCHES BEFORE FIRST MOWING. HYDROMULCHED AREAS SHALL SHOW ACTIVE, HEALTHY GROWTH. BARE AREAS LARGER THAN TWELVE SQUARE INCHES MUST BE RESODDED OR RESEEDED (AS APPROPRIATE) PRIOR TO FINAL ACCEPTANCE. ALL SODDED TURF SHALL BE NEATLY MOWED.

- A. TREES. SHRUBS. GROUNDCVOER SHALL BE GUARANTEED (IN WRITING) FOR A 12 MONTH PERIOD (90 DAYS FOR ANNUAL PLANTING OR AT THE FND OF THE SEASONAL COLOR GROWING SEASON, WHICHEVER COMES SOONER) AFTER FINAL ACCEPTANCE. THE CONTRACTOR SHALL REPLACE ALL DEAD MATERIALS AS SOON AS WEATHER PERMITS AND UPON NOTIFICATION OF
- B. PLANTS INCLUDING TREES. WHICH HAVE PARTIALLY DIED SO THAT SHAPE SIZE OR SYMMETRY HAVE BEEN DAMAGED SHALL BE CONSIDERED SUBJECT O REPLACEMENT. IN SUCH CASES, THE OPINION OF THE OWNER SHALL BE
- C. PLANTS USED FOR REPLACEMENT SHALL BE OF THE SAME SIZE AND KIND AS THOSE ORIGINALLY PLANTED OR SPECIFIED. ALL WORK INCLUDING MATERIALS, LABOR AND EQUIPMENT USED IN REPLACEMENTS SHALL CARRY A 12 MONTH GUARANTEE. ANY DAMAGE INCLUDING RUTS IN LAWN OR BED AREAS INCURRED AS A RESULT OF MAKING REPLACEMENTS SHALL BE IMMEDIATELY REPAIRED.
- D. WHEN PLANT REPLACEMENTS ARE MADE, PLANTS, SOIL MIX, FERTILIZER AND MULCH ARE TO BE UTILIZED AS ORIGINALLY SPECIFIED AND RE-INSPECTED FOR FULL COMPLIANCE WITH THE CONTRACT REQUIREMENTS. ALL REPLACEMENTS ARE INCLUDED UNDER "WORK" OF THIS SECTION.
- E. THE OWNER AGREES THAT FOR THE ONE YEAR WARRANTY PERIOD TO BE EFFECTIVE, HE WILL WATER PLANTS AT LEAST TWICE A WEEK DURING DRY
- F. THE ABOVE GUARANTEE SHALL NOT APPLY WHERE PLANTS DIE AFTER ACCEPTANCE BECAUSE OF DAMAGE DUE TO ACTS OF GOD, VANDALISM, INSECTS, DISEASE, INJURY BY HUMANS, MACHINES, THEFT OR NEGLIGENCE
- G. ACCEPTANCE FOR ALL LANDSCAPE WORK SHALL BE GIVEN AFTER FINAL INSPECTION BY THE OWNER PROVIDED THE JOB IS IN A COMPLETE, UNDAMAGED CONDITION AND THERE IS A STAND OF GRASS IN ALL LAWN AREAS. AT THAT TIME, THE OWNER WILL ASSUME MAINTENANCE ON THE ACCEPTED WORK.

1.9 QUALITY ASSURANCE

"S" HOOK

DRIVE ROD

DETAIL A

TREE ROOT BALL - ROOT ANCHOR

- TREE TRUNK

- U-BRACKET

— TIGHTENING STRAP

A. COMPLY WITH ALL FEDERAL, STATE, COUNTY AND LOCAL REGULATIONS GOVERNING LANDSCAPE MATERIALS AND WORK. B. EMPLOY PERSONNEL EXPERIENCED AND FAMILIAR WITH THE REQUIRED

ROOT ANCHOR ITEM# ROOT BALL & CONTAINER SIZE ANCHOR INSTALLATION DEPTH QUANTITY & ANCHOR SI

0 / 39 Gallon or 22" root ball

200 Gallon or 48" root ball

Root Balls larger than 60"

WORK AND SUPERVISION BY A FOREMAN.

- C. MAKE CONTACT WITH SUPPLIERS IMMEDIATELY UPON OBTAINING NOTICE OF CONTRACT ACCEPTANCE TO SELECT AND BOOK MATERIALS. D. DEVELOP A PROGRAM OF MAINTENANCE (PRUNING AND FERTILIZATION) WHICH WILL ENSURE THE PURCHASED MATERIALS WILL MEET AND/OR
- EXCEED PROJECT SPECIFICATIONS. E. DO NOT MAKE PLANT MATERIAL SUBSTITUTIONS. IF THE LANDSCAPE MATERIAL SPECIFIED IS NOT READILY AVAILABLE, SUBMIT PROOF TO
- LANDSCAPE ARCHITECT ALONG WITH THE PROPOSED MATERIAL TO BE USED IN LIEU OF THE SPECIFIED PLANT. F. AT THE TIME BIDS ARE SUBMITTED, THE CONTRACTOR IS ASSUMED TO HAVE LOCATED THE MATERIALS NECESSARY TO COMPLETE THE JOB AS
- G OWNER'S REPRESENTATIVE SHALL INSPECT ALL PLANT MATERIAL AND RETAINS THE RIGHT TO INSPECT MATERIALS UPON ARRIVAL TO THE SITE AND DURING INSTALLATION. THE OWNER'S REPRESENTATIVE MAY ALSO REJECT ANY MATERIALS HE/SHE FEELS TO BE UNSATISFACTORY OR DEFECTIVE DURING THE WORK PROCESS. ALL PLANTS DAMAGED IN TRANSIT OR AT THE JOB SITE SHALL BE REJECTED.

1.10 PRODUCT DELIVERY, STORAGE AND HANDLING

1. BALLED AND BURLAPPED B&B PLANTS): DIG AND PREPARE SHIPMENT IN A MANNER THAT WILL NOT DAMAGE ROOTS, BRANCHES, SHAPE AND FUTURE 2. CONTAINER GROWN PLANTS: DELIVER PLANTS IN RIGID CONTAINER TO

HOLD BALL SHAPE AND PROTECT ROOT MASS. B. DELIVERY 1. DELIVER PACKAGED MATERIALS IN SEALED CONTAINERS SHOWING

WEIGHT, ANALYSIS AND NAME OF MANUFACTURER. PROTECT MATERIALS FROM DETERIORATION DURING DELIVERY AND WHILE STORED ON SITE. 2 DELIVER ONLY PLANT MATERIALS THAT CAN BE PLANTED IN ONE DAY UNLESS ADEQUATE STORAGE AND WATERING FACILITIES ARE AVAILABLE 3. PROTECT ROOT BALLS BY HEELING IN WITH SAWDUST OR OTHER

APPROVED MOISTURE RETAINING MATERIAL IF NOT PLANTED WITHIN 24 HOURS OF DELIVERY. 4. PROTECT PLANTS DURING DELIVERY TO PREVENT DAMAGE TO ROOT BALL OR DESICCATION OF LEAVES. 5. KEEP PLANTS MOIST AT ALL TIMES. COVER ALL MATERIALS DURING 6. NOTIFY OWNERS REPRESENTATIVE OF DELIVERY 72 HOURS PRIOR TO

DELIVERY OF PLANT MATERIAL AT JOB SITE. 7. REMOVE REJECTED PLANT MATERIAL IMMEDIATELY FROM JOB SITE. 8. TO AVOID DAMAGE OR STRESS, DO NOT LIFT, MOVE, ADJUST TO PLUMB, OR OTHERWISE MANIPULATE PLANTS BY TRUNK OR STEMS.

A. GENERAL: WELL FORMED NO. 1 GRADE OR BETTER NURSERY GROWN STOCK, LISTED PLANT HEIGHTS ARE FROM TOPS OF FOOT BALLS TO NOMINAL TOPS OF PLANTS. PLANT SPREAD REFERS TO NOMINAL OUTER WIDTH OF THE PLANT NOT THE OUTER LEAF TIPS. PLANTS SHALL BE INDIVIDUALLY APPROVED BY THE OWNERS REPRESENTATIVE AND THEIR DECISION AS TO THEIR ACCEPTABILITY SHALL BE FINAL.

- B. QUANTITIES: THE DRAWINGS AND SPECIFICATIONS ARE COMPLIMENTARY ANYTHING CALLED FOR ON ONE AND NOT THE OTHER IS AS BINDING AS IF SHOWN AND CALLED FOR ON BOTH. THE PLANT SCHEDULE IS AN AID TO BIDDERS ONLY. CONFIRM ALL QUANTITIES ON PLAN.
- C. QUANTITIES AND SIZE: PLANT MATERIALS SHALL CONFORM TO THE SIZE GIVEN ON THE PLAN AND SHALL BE HEALTHY. WELL SHAPED. FULL BRANCHED AND WELL ROOTED. SYMMETRY IS ALSO IMPERATIVE. PLANTS SHALL BE FREE FROM INSECTS, INJURY, DISEASE, BROKEN BRANCHES, DISFIGUREMENTS, INSECT EGGS AND ARE TO BE OF SPECIMEN QUALITY. D. APPROVAL: ALL PLANTS WHICH ARE FOUND UNSUITABLE IN GROWTH OR
- ARE UNHEALTHY, BADLY SHAPED OR UNDERSIZED WILL BE REJECTED BY THE OWNERS REPRESENTATIVE EITHER BEFORE OR AFTER PLANTING AND SHALL BE REMOVED AT THE EXPENSE OF THE LANDSCAPE CONTRACTOR AND REPLACED WITH ACCEPTABLE SPECIMENS. E. TREES SHALL BE HEALTHY, FULL BRANCHED, WELL SHAPED AND SHALI

MEET THE MINIMUM REQUIREMENTS AS SPECIFIED ON THE PLANT

SCHEDULE. ALL TREES SHALL BE OBTAINED FROM SOURCES WITHIN 200

- MILES OF THE PROJECT SITE IF POSSIBLE, AND WITH SIMILAR CLIMACTIC F. PRUNING: ALL PRUNING OF TREES AND SHRUBS SHALL BE EXECUTED BY THE LANDSCAPE CONTRACTOR AT NO ADDITIONAL COST TO THE OWNER, PRIOR TO FINAL ACCEPTANCE.
- G. PLANTS SHALL CONFORM TO THE MEASUREMENTS SPECIFIED, EXCEPT THE PLANTS LARGER THAN THOSE SPECIFIED MAY BE USED. USE OF LARGER PLANTS SHALL NOT INCREASE THE CONTRACT PRICE.

- H. WHERE MATERIALS ARE PLANTED IN MASSES, PROVIDE PLANTS OF
- ROOT SYSTEMS SHALL BE HEALTHY, DENSELY BRANCHED, FIBROUS ROOT SYSTEMS, NON-POT-BOUND, FREE FROM ENCIRCLING AND/OR GIRDLING ROOTS, AND FREE FROM ANY OTHER ROOT DEFECTS (SUCH AS J-SHAPED
- J. ALL TREES SHALL BE STANDARD IN FORM, UNLESS OTHERWISE SPECIFIED. TREES WITH CENTRAL LEADERS WILL NOT BE ACCEPTED IF LEADER IS DAMAGED OR REMOVED. PRUNE ALL DAMAGED TWIGS AFTER PLANTING
- K. TREE TRUNKS TO BE STURDY, EXHIBIT HARDENED SYSTEMS AND VIGOROUS AND FIBROUS ROOT SYSTEMS, NOT ROOT OR POT BOUND. TREES WITH DAMAGED OR CROOKED LEADERS, BARK ABRASIONS,
- SUNSCALD, DISFIGURING KNOTS, OR\INSECT DAMAGE WILL BE REJECTED. M. CALIPER MEASUREMENTS FOR STANDARD (SINGLE TRUNK) TREES SHALL BE AS FOLLOWS: SIX INCHES ABOVE THE ROOT FLARE FOR TREES UP TO AND INCLUDING FOUR INCHES IN CALIPER, AND TWELVE INCHES ABOVE THE ROOT FLARE FOR TREES EXCEEDING FOUR INCHES IN CALIPER

N. MULTI-TRUNK TREES SHALL BE MEASURED BY THEIR OVERALL HEIGHT,

- MEASURED FROM THE TOP OF THE ROOT BALL. O. ANY TREE OR SHRUB SHOWN TO HAVE EXCESS SOIL PLACED ON TOP OF THE ROOT BALL, SO THAT THE ROOT FLARE HAS BEEN COMPLETELY
- COVERED, SHALL BE REJECTED. P. SOD: PROVIDE WELL-ROOTED SOD OF THE VARIETY NOTED ON THE PLANS. SOD SHALL BE CUT FROM HEALTHY, MATURE TURF WITH SOIL THICKNESS OF 3/4" TO 1". EACH PALLET OF SOD SHALL BE ACCOMPANIED BY A CERTIFICATE FROM SUPPLIER STATING THE COMPOSITION OF THE SOD.

2.2 SOIL PREPARATION MATERIALS A. SANDY LOAM:

- 1. FRIABLE, FERTILE, DARK, LOAMY SOIL, FREE OF CLAY LUMPS, SUBSOIL, STONES AND OTHER EXTRANEOUS MATERIAL AND REASONABLY FREE OF WEEDS AND FOREIGN GRASSES. LOAM CONTAINING DALLASGRASS OR
- NUTGRASS SHALL BE REJECTED. 2. PHYSICAL PROPERTIES AS FOLLOWS: a. CLAY – BETWEEN 7-27%
- b. SILT BETWEEN 15-25%
- c. SAND LESS THAN 52% 3. ORGANIC MATTER SHALL BE 3%-10% OF TOTAL DRY
- 4. IF REQUESTED, LANDSCAPE CONTRACTOR SHALL PROVIDE A CERTIFIED SOIL ANALYSIS CONDUCTED BY AN APPROVED SOIL TESTING LABORATORY VERIFYING THAT
- SANDY LOAM MEETS THE ABOVE REQUIREMENTS. B. ORGANIC MATERIAL: COMPOST WITH A MIXTURE OF 80% VEGETATIVE MATTER AND 20% ANIMAL WASTE. INGREDIENTS SHOULD BE A MIX OF COURSE AND FINE TEXTURED MATERIAL PREMIXED BEDDING SOIL AS SUPPLIED BY VITAL EARTH RESOURCES, GLADEWATER, TEXAS; PROFESSIONAL BEDDING SOIL AS SUPPLIED BY
- MUNICIPAL MIX AS SUPPLIED BY SOIL BUILDING SYSTEMS, DALLAS, TEXAS OR APPROVED EQUAL D. SHARP SAND: SHARP SAND MUST BE FREE OF SEEDS, SOIL PARTICLES

LIVING EARTH TECHNOLOGY, DALLAS, TEXAS OR ACID GRO

- E. MULCH: DOUBLE SHREDDED HARDWOOD MULCH, PARTIALLY DECOMPOSED, DARK BROWN.
- F. ORGANIC FERTILIZER: FERTILAID, SUSTANE, OR GREEN SENSE OR EQUAL AS RECOMMENDED FOR REQUIRED APPLICATIONS. FERTILIZER SHALL BE DELIVERED TO THE SITE IN ORIGINAL UNOPENED CONTAINERS, EACH BEARING THE MANUFACTURER'S GUARANTEED
- STATEMENT OF ANALYSIS. G. COMMERCIAL FERTILIZER: 10-20-10 OR SIMILAR ANALYSIS. NITROGEN SOURCE TO BE A MINIMUM 50% SLOW RELEASE ORGANIC NITROGEN CU OR UF) WITH A MINIMUM 8% SULFUR AND 4% IRON, PLUS
- MICRONUTRIENTS. H. PEAT: COMMERCIAL SPHAGNUM PEAT MOSS OR PARTIALLY DECOMPOSED SHREDDED PINE BARK OR OTHER APPROVED ORGANIC

2.3 MISCELLANEOUS MATERIALS

- A. STEEL EDGING SHALL BE 3/16" X 4" X 16" DARK GREEN LANDSCAPE EDGING. DURAEDGE STEEL OR APPROVED EQUAL. B. TREE STAKING - TREE STAKING SOLUTIONS OR APPROVED SUBSTITUTE;
- REFER TO DETAILS. C. FILTER FABRIC - MIRAFI 1405 BY MIRAFI INC. OR APPROVED SUBSTITUTE.
- AVAILABLE AT LONE STAR PRODUCTS, INC. (469-523-0444) D. SAND - UNIFORMLY GRADED, WASHED, CLEAN, BANK RUN SAND.
- E. GRAVEL: WASHED NATIVE PEA GRAVEL, GRADED 1" TO 1.5" F. DECOMPOSED GRANITE - BASE MATERIAL OF NATURAL MATERIAL MIX OF

- GRANITE AGGREGATE NOT TO EXCEED 1/8" IN DIAMETER COMPOSED OF VARIOUS STAGES OF DECOMPOSED EARTH BASE.
- G. RIVER ROCK LOCALLY AVAILABLE NATIVE RIVER ROCK BETWEEN 2"-4" IN H. PRE-EMERGENT HERBICIDES: ANY GRANULAR, NON-STAINING PRE-EMERGENT HERBICIDE THAT IS LABELED FOR THE SPECIFIC ORNAMENTALS OR TURF ON WHICH IT WILL BE UTILIZED. PRE-EMERGENT

HERBICIDES SHALL BE APPLIED PER THE MANUFACTURER'S LABELED RATES. PART 3 - EXECUTION

- A. LANDSCAPE CONTRACTOR TO INSPECT ALL EXISTING CONDITIONS AND REPORT ANY DEFICIENCIES TO THE OWNER
- B. ALL PLANTING AREAS SHALL BE CONDITIONED AS FOLLOWS 1. PREPARE NEW PLANTING BEDS BY SCRAPING AWAY EXISTING GRASS AND WEEDS AS NECESSARY. TILL EXISTING SOIL TO A DEPTH OF SIX (6") INCHES PRIOR TO PLACING COMPOST AND FERTILIZER. APPLY FERTILIZER AS PER MANUFACTURER'S RECOMMENDATIONS. ADD SIX (6") INCHES OF COMPOST AND TILL INTO A DEPTH OF SIX (6") INCHES OF SPECIFIED MULCH (SETTLED THICKNESS). 2. BACKFILL FOR TREE PITS SHALL BE AS FOLLOWS: USE EXISTING TOP SOIL ON SITE (USE IMPORTED TOPSOIL AS NEEDED) FREE FROM
- C. GRASS AREAS: 1. BLOCKS OF SOD SHOULD BE LAID JOINT TO JOINT (STAGGERED JOINTS) AFTER FERTILIZING THE GROUND FIRST. ROLL GRASS AREAS TO ACHIEVE A SMOOTH, EVEN SURFACE. THE JOINTS BETWEEN THE BLOCKS OF SOD SHOULD BE FILLED WITH TOPSOIL WHERE THEY ARE GAPED OPEN, THEN WATERED THOROUGHLY.

IN NINE (9") INCH LAYERS AND WATERED IN THOROUGHLY.

LARGE CLUMPS, ROCKS, DEBRIS, CALICHE, SUBSOILS, ETC., PLACED

3.2 INSTALLATION

- A. MAINTENANCE OF PLANT MATERIALS SHALL BEGIN IMMEDIATELY AFTER EACH PLANT IS DELIVERED TO THE SITE AND SHALL CONTINUE CONSTRUCTION HAS BEEN SATISFACTORILY ACCOMPLISHED.
- B PLANT MATERIALS SHALL BE DELIVERED TO THE SITE ONLY AFTER THE BEDS ARE PREPARED AND AREAS ARE READY FOR PLANTING. ALL SHIPMENTS OF NURSERY MATERIALS SHALL BE THOROUGHLY PROTECTED FROM THE WINDS DURING TRANSIT. ALL PLANTS WHICH CANNOT BE PLANTED AT ONCE, AFTER DELIVERY TO THE SITE, SHALI BE WELL PROTECTED AGAINST THE POSSIBILITY OF DRYING BY WIND AND BALLS OF EARTH OF B & B PLANTS SHALL BE KEPT COVERED WITH SOIL OR OTHER ACCEPTABLE MATERIAL. ALL PLANTS REMAIN THE PROPERTY OF THE CONTRACTOR UNTIL FINAL ACCEPTANCE.
- C. POSITION THE TREES AND SHRUBS IN THEIR INTENDED LOCATION AS D. NOTIFY THE OWNER'S AUTHORIZED REPRESENTATIVE FOR INSPECTION
- AND APPROVAL OF ALL POSITIONING OF PLANT MATERIALS. E. EXCAVATE PITS WITH VERTICAL SIDES AND HORIZONTAL BOTTOM TREE PITS SHALL BE LARGE ENOUGH TO PERMIT HANDLING AND PLANTING WITHOUT INJURY TO BALLS OF EARTH OR ROOTS AND SHALL BE OF SUCH DEPTH THAT, WHEN PLANTED AND SETTLED, THE CROWN OF THE PLANT SHALL BEAR THE SAME RELATIONSHIP TO THE FINISH GRADE AS IT DID TO SOIL SURFACE IN ORIGINAL PLACE OF GROWTH. THE SIDES OF THE HOLE SHOULD BE ROUGH AND JAGGED, NEVER SLICK OR GLAZED
- F. SHRUB AND TREE PITS SHALL BE NO LESS THAN TWENTY-FOUR (24") INCHES WIDER THAN THE LATERAL DIMENSION OF THE EARTH BALL AND SIX (6") INCHES DEEPER THAN IT'S VERTICAL DIMENSION. REMOVE AND HAUL FROM SITE ALL ROCKS AND STONES OVER THREE-QUARTER (3/4") INCH IN DIAMETER. PLANTS SHOULD BE THOROUGHLY MOIST BEFORE REMOVING CONTAINERS. G. PERCOLATION TEST: FILL THE HOLE WITH WATER. IF THE WATER

LEVEL DOES NOT PERCOLATE WITHIN 24 HOURS, THE TREE NEEDS TO

- MOVE TO ANOTHER LOCATION OR HAVE DRAINAGE ADDED. INSTALL A PVC STAND PIPE PER TREE IF THE PERCOLATION TEST FAILS. H. BACKFILL ONLY WITH 5 PARTS EXISTING SOIL OR SANDY LOAM AND 1 PART BED PREPARATION. WHEN THE HOLE IS DUG IN SOLID ROCK
- TOPSOIL FROM THE SAME AREA SHOULD NOT BE USED. CAREFULLY SETTLE BY WATERING TO PREVENT AIR POCKETS. REMOVE THE BURLAP FROM THE TOP $rac{1}{3}$ OF THE BALL, AS WELL AS ALINYLON, PLASTIC STRING AND WIRE. CONTAINER TREES WILL USUALLY BE ROOT BOUND, IF SO FOLLOW STANDARD NURSERY PRACTICE OF 'ROOT SCORING'
- DO NOT WRAP TREES. J. DO NOT OVER PRUNE
- K. REMOVE NURSERY TAGS AND STAKES FROM ALL PLANTS L. REMOVE BOTTOM OF PLANT BOXES PRIOR TO PLACING PLANTS. REMOVE

SIDES AFTER PLACEMENT AND PARTIAL BACKFILLING.

- M. REMOVE UPPER THIRD OF BURLAP FROM BALLED AND BURLAPPED TREES AFTER PLACEMENT.
- N. PLACE PLANT UPRIGHT AND PLUMB IN CENTER OF HOLE. ORIENT PLANTS FOR BEST APPEARANCE
- O. MULCH THE TOP OF THE BALL. DO NOT PLANT GRASS ALL THE WAY TO THE TRUNK OF THE TREE. LEAVE THE AREA ABOVE THE TOP OF THE BALL AND MULCH WITH AT LEAST TWO (2") INCHES OF SPECIFIED
- P. ALL PLANT BEDS AND TREES TO BE MULCHED WITH A MINIMUM SETTLED THICKNESS OF TWO (2") INCHES OVER THE ENTIRE BED OR
- Q. OBSTRUCTION BELOW GROUND: IN THE EVENT THAT ROCK, OR UNDERGROUND CONSTRUCTION WORK OR OBSTRUCTIONS AR ENCOUNTERED IN ANY PLANT PIT EXCAVATION WORK TO BE DONE UNDER THIS SECTION, ALTERNATE LOCATIONS MAY BE SELECTED BY THE OWNER. WHERE LOCATIONS CANNOT BE CHANGED, THE OBSTRUCTIONS SHALL BE REMOVED TO A DEPTH OF NOT LESS THAN HREE (3') FEET BELOW GRADE AND NO LESS THAN SIX (6") INCHES BELOW THE BOTTOM OF BALL WHEN PLANT IS PROPERLY SET AT THE REQUIRED GRADE. THE WORK OF THIS SECTION SHALL INCLUDE THE REMOVAL FROM THE SITE OF SUCH ROCK OR UNDERGROUND OBSTRUCTIONS ENCOUNTERED AT THE COST OF THE LANDSCAPE CONTRACTOR.
- R. TREES AND LARGE SHRUBS SHALL BE STAKED AS SITE CONDITIONS REQUIRE. POSITION STAKES TO SECURE TREES AGAINST SEASONAL PREVAILING WINDS.
- S. PRUNING AND MULCHING: PRUNING SHALL BE DIRECTED BY THE LANDSCAPE ARCHITECT AND SHALL BE PRUNED IN ACCORDANCE VITH STANDARD HORTICULTURAL PRACTICE FOLLOWING FINE PRUNING, CLASS I PRUNING STANDARDS PROVIDED BY THE NATIONAL ARBORIST ASSOCIATION.
- 1. DEAD WOOD, SUCKERS, BROKEN AND BADLY BRUISED BRANCHES SHALL BE REMOVED. GENERAL TIPPING OF THE BRANCHES IS NOT PERMITTED. DO NOT CUT TERMINAL
- 2. PRUNING SHALL BE DONE WITH CLEAN, SHARP TOOLS. IMMEDIATELY AFTER PLANTING OPERATIONS ARE COMPLETED, LL TREE PITS SHALL BE COVERED WITH A LAYER OF ORGANIC MATERIAL TWO (2") INCHES IN DEPTH. THIS LIMIT OF THE ORGANIC MATERIAL FOR TREES SHALL BE THE DIAMETER OF THE PLANT PIT.
- Q. STEEL EDGE INSTALLATION: EDGE SHALL BE ALIGNED AS INDICATED ON PLANS. STAKE OUT LIMITS OF STEEL CURBING AND OBTAIN OWNERS APPROVAL PRIOR TO INSTALLATION. ALL STEEL CURBING SHALL BE FREE OF KINKS AND ABRUPT TOP OF EDGING SHALL BE ½" MAXIMUM HEIGHT ABOVE FINAL FINISHED GRADE. 3. STAKES ARE TO BE INSTALLED ON THE PLANTING BED SIDE OF THE CURBING, AS OPPOSED TO THE GRASS SIDE. 4. DO NOT INSTALL STEEL EDGING ALONG SIDEWALKS OR

3.3 CLEANUP AND ACCEPTANCE A. CLEANUP: DURING THE WORK, THE PREMISES SHALL BE KEPT NEAT AND ORDERLY AT ALL TIMES. STORAGE AREAS FOR ALL MATERIALS SHALL BE SO ORGANIZED SO THAT THEY, TOO, ARE NEAT AND ORDERLY. ALL TRASH AND DEBRIS SHALL BE REMOVED FROM THE

MEETS SIDEWALKS OR CURBS.

5. CUT STEEL EDGING AT 45 DEGREE ANGLE WHERE EDGING


- SITE AS WORK PROGRESSES. KEEP PAVED AREAS CLEAN BY SWEEPING OR HOSING THEM AT END OF EACH WORK DAY B. REPAIR RUTS, HOLES AND SCARES IN GROUND SURFACES. C. ENSURE THAT WORK IS COMPLETE AND PLANT MATERIALS ARE IN
- VIGOROUS AND HEALTHY GROWING CONDITION. D. UPON COMPLETION OF THE WORK, THE LANDSCAPE CONTRACTOR SHALL PROVIDE THE SITE CLEAN, FREE OF DEBRIS AND TRASH, AND SUITABLE FOR USE AS INTENDED. THE LANDSCAPE CONTRACTOR SHALL THEN REQUEST AN INSPECTION BY THE OWNER TO DETERMINE FINAL ACCEPTABILITY.


F. WHEN/IF THE INSPECTED PLANTING WORK DOES NOT COMPLY WITH THE

CONTRACT DOCUMENTS THE LANDSCAPE CONTRACTOR SHALL BEPLACE

AND/OR REPAIR THE REJECTED WORK TO THE OWNER'S SATISFACTION F. THE LANDSCAPE MAINTENANCE PERIOD WILL NOT COMMENCE UNTIL THE LANDSCAPE WORK HAS BEEN RE-INSPECTED BY THE OWNER AND FOUND TO BE ACCEPTABLE AT THAT TIME A WRITTEN NOTICE OF FINAL ACCEPTANCE WILL BE ISSUED BY THE OWNER, AND THE MAINTENANCE AND GUARANTEE PERIODS WILL COMMENCE.

END OF SECTION

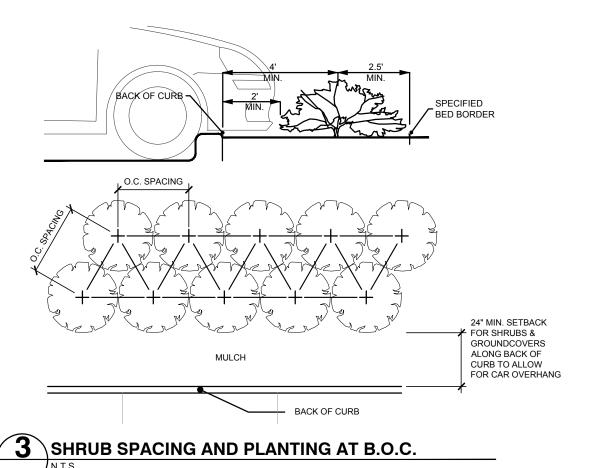


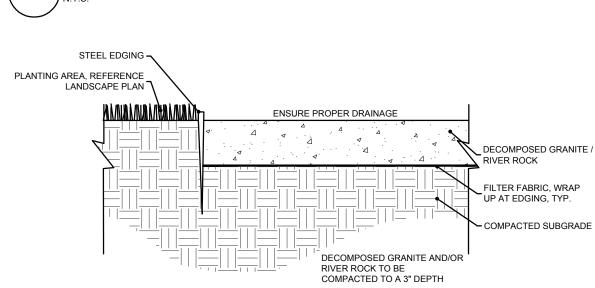

\DECOMPOSED GRANITE / RIVER ROCK

SHRUBS OR GROUNDCOVER AS SPECIFIED ON PLAN TOP OF MULCH SHOULD BE, AT MINIMUM. 1/2" BELOW LAYER OF MULCH, WALK OR CURBIN SETTLED THICKNESS SHOULD BE 2" MIN. **CURB OR SIDEWALK** NO STEEL EDGING ROOT BALL, DO NOT ALONG WALK, TY PLANTING SOIL MIX. TILL IN WITH PARTS EXISTING SOIL. EXCLUDING LARGE CLODS AND ROCKS. REF. LANDSCAPE PLAN FOR SPACING UNDISTURBED SUBGRADE / NATIVE SOIL **SHRUB PLANTING**

SHRUBS AND GROUNDCOVER REFER TO PLANS FOR PLANT TYPE PREPARED SOIL MIX PER SPECIFICATIONS MULCH PER SPECIFICATIONS 3/16" X 4" X 16" STEEL EDGING WITH SIDEWALKS

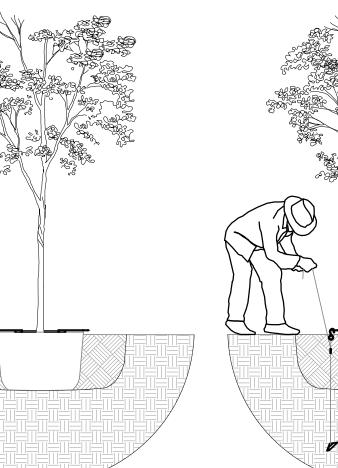

- DRIVE ANCHOR STRAIGHT DOWN INTO UNDISTURBED SUBBASE SOIL SEE CHART FOR RECOMMENDED DEPTHS PER TREE SIZE CENTER ROOT ANCHOR'S INNER RING(S) AROUND TRUNK OF TREE

TREE STAKE SOLUTIONS, LLO


9973 FM 521 Road

Rosharon, Texas 77583

- Phone: 281-778-1400 Mobile: 903-676-6143 281-778-1425
- REMOVE DRIVE ROD REPEAT STEPS 1 & 2 FOR ALL THREE (3) ANCHOR LOCATIONS • PULL BACK ON STRAP APPROXIMATELY 3" FOR THE V-68 ANCHOR, OR 6" TO 7" FOR THE V-88 ANCHOR TO SET ANCHOR INTO A HORIZONTAL OR LOCKED POSITION. A FULCRUM MAY BE REQUIRED TO ASSIST IN SETTING THE

PLACE "S" HOOK OVER THE END OF THE U-BRACKET

• PULL STRAP UP VERTICALLY UNTIL ROOT ANCHOR RINGS BITE INTO THE TOP OF THE ROOT BALL AND U-BRACKETS ARE SETTING FLUSH ON TOP OF • TIE EXCESS STRAP OFF TO THE U-BRACKET ALLOWING ENOUGH REMAINING STRAP TO ADJUST TREE, IF NECESSARY

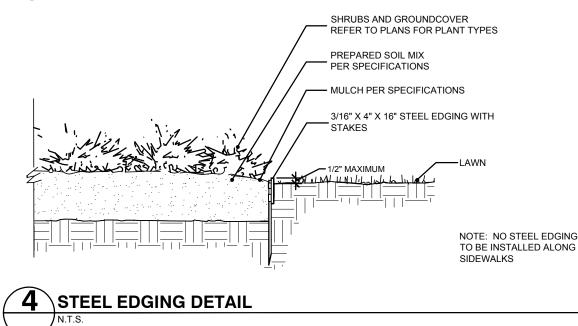

Aledo, Texas 76008 amanda@awr-designs.com

Being Lot 2 of Addison Oaks Addition to the City of Addison, Dallas County Texas. According to the Plat thereof recorded under Volume 89166 Page 1974, Map Records, Denton County, Texas.

Town of Addison Project Number 1823-2

REVISIONS Description **ISSUE DATE**

<u>ACTION</u>

DENIED

Initials

Initials

APPROVED

COUNCIL

Date

Date

ARCHITECT

CLINT NORTON

Email: clint@oakdbbq.com

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See the Staff Approval Letter or

Council Result Memo for any

conditions associated with the

approval of the project.

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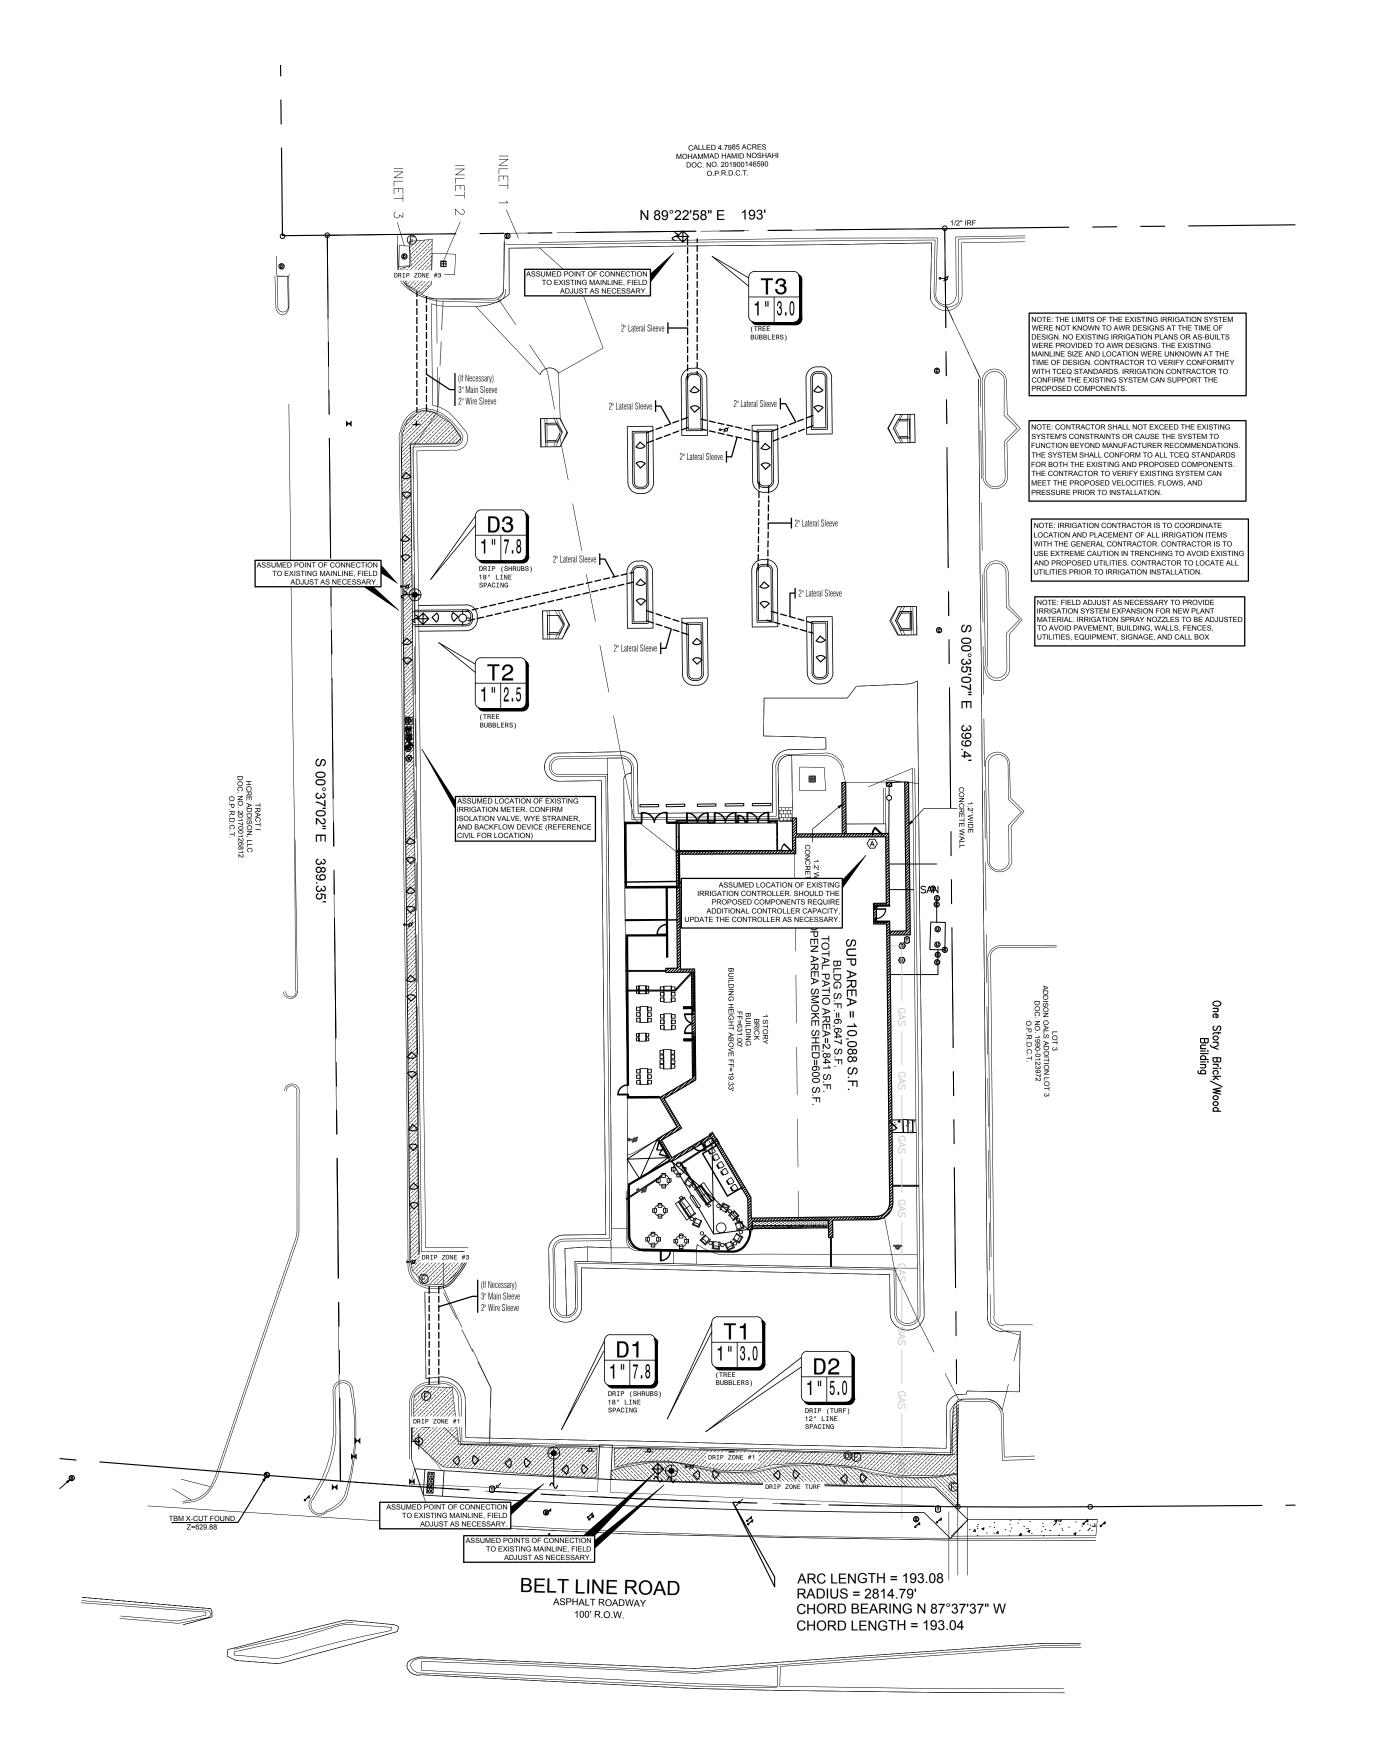
 \Box

9 FOR COUNCIL REVIEW 02/26/21 SHEET TITLE **LANDSCAPE**

SHEET NO.

SPECS &

DETAILS



SLEEVING NOTES

- 1. PIPING AND CONTROL WIRES SHALL BE INSTALLED IN SEPARATE SLEEVES UNDER PAVING. REFERENCE DRAWINGS FOR SLEEVE SIZE AND LOCATION.
- 2. SLEEVES SHALL BE FURNISHED AND INSTALLED BY GENERAL CONTRACTOR.
- 3. INSTALLATION OF SLEEVES SHALL BE TWENTY FOUR (24") BELOW TOP OF PAVEMENT OR FINISHED GRADE.
- 4. SLEEVES SHALL EXTEND ONE (1') FOOT BEYOND EDGE OF ALL PAVEMENT AND
- 5. ALL SLEEVES SHALL BE SCHEDULE 40 PVC PIPE, CAPPED ON BOTH ENDS AND SIZED AT LEAST TWO TIMES LARGER THAN THE DIAMETER OF THE PIPE INSIDE THE SLEEVE.
- 6. SLEEVE LOCATIONS SHALL BE MARKED ONTO THE CURB WITH A SAWCUT OF TWO PARALLEL LINES THAT ARE TWO (2") INCHES LONG AND ONE (1") APART. 7. CONTRACTOR IS RESPONSIBLE FOR THE INSTALLATION OF SLEEVES AND SHALL
- DURING THE INSTALLATION OF THE SYSTEM. 8. CONTRACTOR SHALL FURNISH OWNER AND IRRIGATION CONTRACTOR WITH AN 'AS-BUILT' DRAWING SHOWING ALL SLEEVE LOCATIONS.

ALSO BE RESPONSIBLE FOR LOCATING ANY SLEEVE THAT CANNOT BE FOUND

IRRIGATION GENERAL NOTES

- 1. THE IRRIGATION CONTRACTOR SHALL COORDINATE INSTALLATION OF THE IRRIGATION SYSTEM WITH THE LANDSCAPE CONTRACTOR SO THAT ALL PLANT MATERIAL WILL BE WATERED IN ACCORDANCE WITH THE INTENT OF THE PLANS AND SPECIFICATIONS.
- 2. THE CONTRACTOR SHALL BE RESPONSIBLE TO NOTIFY THE IRRIGATION DESIGNER OF SITE CONDITIONS OR ASSUME FULL RESPONSIBILITY FOR ANY AND ALL ON SITE REVISIONS NECESSARY.
- 3. CONTRACTOR TO VERIFY DESIGN AND ITS INTENT TO PROVIDE FULL COVERAGE TO ALL NEW PLANTING MATERIAL.
- 4. NOTIFY IRRIGATION DESIGNER OF ANY LAYOUT DISCREPANCIES PRIOR TO BIDDING. 5. LOCATE ALL UTILITIES AND SITE LIGHTING CONDUITS BEFORE IRRIGATION
- INSTALLATION BEGINS.
- 6. IRRIGATION CONTRACTOR TO PROCURE ALL PERMITS, LICENSES AND GIVE ALL NECESSARY NOTICES THROUGHOUT THE DURATION OF THE PROJECT.
- 7. THE CONTRACTOR SHALL BE A REGISTERED LICENSED IRRIGATOR IN GOOD STANDING WITH THE STATE OF TEXAS BOARDS AND REGULATORS.
- 8. THE CONTRACTOR SHALL BE RESPONSIBLE FOR ANY AND ALL PLANT MATERIAL UPON ACCEPTANCE AND THROUGH THE WARRANTY PERIOD FOR DAMAGE DUE TO IRRIGATION SYSTEM FAILURE.
- 9. ALL ASPECTS OF THE IRRIGATION INSTALLATION SHALL CONFORM WITH THE PROPER GOVERNING AUTHORITIES, CODES AND ORDINANCES. 10. SLEEVES SHALL BE FURNISHED AND INSTALLED BY GENERAL CONTRACTOR.
- SLEEVE MATERIAL SHALL BE SCHEDULE 40, SIZE AS INDICATED ON PLAN. REFER TO 11. ALL MAIN LINE AND LATERAL LINE PIPING IN PLANTING AND LAWN AREAS SHALL
- HAVE A MINIMUM OF 12 INCHES OF COVER. ALL PIPING UNDER PAVING SHALL HAVE A MINIMUM OF 18 INCHES OF COVER. CONTRACTOR TO VERIFY LOCAL FREEZE DEPTHS AND ADJUST DEPTH OF COVER ACCORDINGLY.
- 12. ZONE VALVES SHALL NOT BE LOCATED WITHIN THREE (3') FEET OF ANY DRIVEWAY, TRAFFIC AISLE, ISLAND ETC. WHERE THEY WILL BE DAMAGED BY VEHICLES DRIVING
- 13. ALL NOZZLES IN PARKING LOT ISLANDS AND PLANTING BEDS SHALL BE LOW ANGLE NOZZLES TO MINIMIZE OVER SPRAY ON PAVEMENT SURFACES.
- 14. AUTOMATIC CONTROLLER SHALL BE INSTALLED AT LOCATION SHOWN. POWER (120V) SHALL BE LOCATED IN A JUNCTION BOX WITHIN FIVE (5') FEET OF CONTROLLER, LOCATION BY OTHER TRADES. RAIN AND FREEZE SENSORS SHALL BE INSTALLED WITH EACH CONTROLLER.
- 15. ELECTRICAL SPLICES SHOULD BE LOCATED AT EACH VALVE AND CONTROLLER
- 16. PROVIDE A 3/4" BLOW DOWN DRAIN TEE TO ALLOW WATER TO BE BLOWN FROM THE
- 17. DISTURBED AREAS IN NEED OF TURF ESTABLISHMENT MAY EXIST BEYOND COVERAGE LIMITS OF THE PERMANENT IRRIGATION SYSTEM. IN THESE AREAS, CONTRACTOR TO DETERMINE A TEMPORARY MEANS TO ESTABLISH NECESSARY TURF. CONTRACTOR IS ENCOURAGED TO BEGIN TURF ESTABLISHMENT IMMEDIATELY UPON FINAL GRADE IN ACCORDANCE WITH AND TO SATISFY SWPPP.
- 18. PROVIDE WITH OWNER A COPY OF ALL INSTALLED EQUIPMENT AND LINES (AS BUILT
- 19. PLACE COPY OF ZONE MAP WITH ALL ZONE VALVE LOCATIONS SHOWN AND APPROVED IRRIGATION PLAN IN PROTECTIVE JACKET IN MAIN CONTROL PANEL.
- 20. IRRIGATION IN TEXAS IS REGULATED BY: THE TEXAS COMMISSION ON ENVIRONMENTAL QUALITY (TCEQ) MC-178 / PO BOX 13087 AUSTIN. TEXAS 78711-3087 WWW.TECQ.STATE.TX.US.

SYMBOL	DESCRIPTION	MANUFACTURER	MODEL NO.
\Diamond	TREE ROOT BUBBLER SYSTEM	HUNTER	RZWS-18-25
•	REMOTE CONTROL VALVE	HUNTER	ICV
×	FIELD VERIFY EXISTING BACKFLOW	DEVICE	
\bigoplus	FULL-CIRCLE BUBBLERS	HUNTER	PROS-06-PRS30 WITH PCN25 NOZZLES
	HDL DRIPLINE	HUNTER	HDL-06-12-CV
(Ē)	LINE FLUSHING VALVE	HUNTER	AFV-B
0	PRESSURE OPERATOR INDICATOR	HUNTER	ECO-ID
(DRIP CONTROL VALVE	HUNTER	ICZ-101-LF-25

♥	DRIP CONTROL VALVE	HUNTER	ICZ-101-LF-25
		·	•
IRRIGATION L	EGEND		
SYMBOL	DESCRIPTION		
\blacksquare	EXISTING IRRIGATION METER		
$\langle A \rangle$	EXISTING CONTROLLER		
H	ISOLATION VALVE		
	LATERAL PIPING	REFER TO PLAN	CLASS 200 PVC
<u> </u>	MAINLINE PIPING REFER TO	PLAN SCH. 40 PVC, SIZED A	S SHOWN (INSTALL THRUST BLOCKS AS NECESSARY)
======	IRRIGATION SLEEVE, SCH. 40 P	VC, MIN. TWICE SIZE OF PIPE TO	BE INSERTED, ONE SLEEVE PER PIPE
	CONTROL WIRING SLEEVE, 2" S	CH. 40 PVC	
\square	VALVE STATION # (WHERE D =	ORIP TUBING, S = SPRAY, R = RO	OR, T = TREE DRIP)
1"8.8 VALVE SIZE			
0.0	GPM		
	1		

GRAPHIC SCALE

Scale 1"=30' - 0"

IRRIGATION PROJECT NOTES

- 1. THE LOCATION OF MAINLINE AND VALVES ON THIS PLAN MAY BE SHOWN IN PAVED AREAS FOR DESIGN CLARITY ONLY. IRRIGATION ELEMENTS HAVE BEEN SHOWN ON THIS PLAN AS ACCURATELY AS POSSIBLE WITHOUT THE FORFEIT OF DESIGN CLARITY AND INTENT. ALL PIPES AND VALVES SHALL BE INSTALLED WITHIN PERVIOUS AREAS. ALL PIPE AND WIRES THAT CROSS UNDER PAVING SHALL BE INSTALLED IN SEPARATE SLEEVES AS SPECIFIED.
- 2. ALL SPRINKLER EQUIPMENT NUMBERS REFERENCE THE HUNTER EQUIPMENT CATALOG UNLESS OTHERWISE INDICATED.
- 3. TEN DAYS PRIOR TO START OF CONSTRUCTION, IRRIGATION CONTRACTOR SHALL VERIFY STATIC WATER PRESSURE. THE IRRIGATION SYSTEM FOR THIS SITE IS DESIGNED TO OPERATE WITH A PRESSURE OF SIXTY (60 PSI) POUNDS PER SQUARE INCH. SHOULD THE DESIGN PRESSURE FOR THE SYSTEM BE HIGHER THAN THE EXISTING PRESSURE, THE IRRIGATION CONTRACTOR SHALL NOTIFY THE IRRIGATION DESIGNER IMMEDIATELY.
- 4. IRRIGATION CONTRACTOR SHALL COORDINATE THE LOCATION OF THE CONTROLLER AND SENSORS WITH THE GENERAL CONTRACTOR AND OWNER. A 110 VOLT ELECTRICAL SERVICE TO POWER THE IRRIGATION CONTROLLER SHALL BE PROVIDED BY THE GENERAL CONTRACTOR AT THE LOCATION SHOWN ON THIS PLAN.
- 5. WATER SERVICE TAP, METER AND LEAD FOR THE IRRIGATION SYSTEM SHALL BE PROVIDED AND INSTALLED BY THE GENERAL CONTRACTOR. SERVICE LINE AND METER SHALL BE SIZED AS NOTED ON THIS PLAN.
- 6. TYPE AND INSTALLATION OF THE WATER METER AND BACK FLOW PREVENTION DEVICE SHALL BE DETERMINED BY THE GOVERNING AUTHORITY. AN ISOLATION VALVE SHALL BE PROVIDED BETWEEN THE WATER METER AND BACK FLOW
- 7. ALL CALCULATIONS FOR THIS IRRIGATION SYSTEM ARE BASED ON PRODUCTS AND EQUIPMENT INFORMATION PROVIDED BY HUNTER. INSTALLATION OF THESE PRODUCTS SHALL NOT EXCEED MANUFACTURERS RECOMMENDATIONS.
- 8. REFERENCE HUNTER GUIDELINES AND SPECIFICATIONS PRIOR TO INSTALLATION. CONFIRM REQUIREMENTS FOR CONTROLLER WATERPROOF CONNECTIONS GROUNDING, SURGE PROTECTORS, DECODERS, VALUES, AND WIRING PRIOR TO INSTALLATION. HUNTER TECHNICAL SERVICES (760) 591-7383. WWW.HUNTERINDUSTRIES.COM
- 9. IRRIGATION REMOTE CONTROL VALVES SHALL BE 1" AND/OR 1.5" HUNTER ICV AS INDICATED. PRIOR TO ALL REMOTE CONTROL VALVES, INSTALL A NOMINALLY SIZED BALL VALVE WITHIN THE SAME BOX.
- 10. SIZE OF VALVES ARE AS SHOWN ON PLAN. VALVES SHALL BE INSTALLED IN APPROVED BOXES WITH COVERS LARGE ENOUGH TO PERMIT MANUAL OPERATION, REMOVAL OF SOLENOID AND / OR VALVE COVER WITHOUT ANY EARTH EXCAVATION. OWNERS MAY ELECT LOCKING BOXES ON A PROJECT BY PROJECT BASIS.
- 11. UPDATE EXISTING IRRIGATION SYSTEM AUTOMATIC CONTROLLER CAPACITY AS NEEDED. INSTALL RAIN AND FREEZE SENSORS IF NECESSARY
- 12. DRIP IRRIGATION REMOTE CONTROL VALVES SHALL BE HUNTER ICZ-101-LF-25 AS INDICATED. DRIP TUBING SHALL BE HUNTER HDL-06-12-CV.
- 13. INSTALL DRIP TUBING/LINES PER MANUFACTURERS RECOMMENDATIONS. USE PLD-LOC FITTINGS PLD-LOC 075, PLD-LOC 050, PLD-LOC ELB, PLD-LOC CPL, PLD-LOC CAP, PLD-LOC TEE, PLD-LOC OR USE FHS BARB FITTINGS PLD-075, PLD-050, PLD-ELB PLD-CPL, PLD-CAP, PLD-TEE, PLD-075-TBTEE, PLD-BV. USE ECO-INDICATOR ECO-ID. USE LINE FLUSHING VALVE HUNTER AFV-B.
- 14. DRIP TUBING SHALL BE SPACED 18" APART IN SHRUB AREAS. DRIP TUBING SHALL BE SPACED 12" APART IN TURF AREAS. REFER TO MANUFACTURERS RECOMMENDATIONS.
- 15. TREE BUBBLERS SHALL BE HUNTER FULL-CIRCLE BUBBLERS WITH PROS-06-PRS30 WITH PCN MODEL 25 NOZZLES.
- 16. ALL VALVE CONTROL WIRE SHALL BE SIZED PER MANUFACTURER GUIDELINES BY THE CONTRACTOR ACCORDING TO THE ACTUAL FIELD DISTANCE. ALL CONNECTIONS SHALL BE WATER-PROOF, KEPT TO A MINIMUM, AND LOCATED IN ĀN APPROVED BOX.

NOTE TO CONTRACTOR:
ENTIRE SYSTEM SHALL BE INSTALLED PER TCEQ STANDARDS, MANUFACTURER'S SPECIFICATIONS AND ALL CITY CODES.

ARIOUS AREAS ON PLAN ARE SHOWING SINGLE HEAD COVERAGE. IF OWNER SHOULD ELECT TO COVER TO THE CURB LINE, CONTRACTOR TO PROCURE THE PROPER PERMITS AND BID ALTERNATE FOR THESE ADDITIONAL SPRAY HEADS, ZONES, AND CONTROLLER EXPANSION FOR THE SYSTEM.

THIS DESIGN IS DIAGRAMMATIC, ALL PIPING, VALVES, AND OTHER EQUIPMENT SHOWN WITHIN PAVED AREAS OR OUT OF PROPERTY BOUNDARIES ARE FOR DESIGN CLARIFICATION ONLY, AND SHALL BE INSTALLED IN PLANTING AREAS WITHIN THE PROPERTY LINES OR LIMITS INDICATED ON PLAN. THE IRRIGATION CONTRACTOR SHALL VERIFY THE LOCATIONS OF ALL ABOVE GROUND IRRIGATION EQUIPMENT WITH THE OWNER'S AUTHORIZED REPRESENTATIVE PRIOR TO INSTALLATION, OR IRRIGATION CONTRACTOR MAY BE REQUIRED TO MOVE SUCH ITEMS AT HIS OWN COST.

REFERENCE: REFERENCE LANDSCAPE PLAN FOR LOCATION OF GRAVEL, STEEL EDGING AND ALL PROPOSED PLANT MATERIAL.



Know what's below.

Call before you dig.

SHEET TITLE **IRRIGATION PLAN**

FOR COUNCIL REVIEW

02/26/21

ISSUE DATE

MANDA RICHARDSON

REVISIONS

<u>ACTION</u>

DENIED

Initials

Initials

APPROVED

COUNCIL

Date

Date

ARCHITECT

CLINT NORTON

Email: clint@oakdbbq.com

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See the Staff Approval Letter or

Council Result Memo for any conditions associated with the

approval of the project.

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SHEET NO.





Being Lot 2 of Addison Oaks Addition to the City of Addison, Dallas County Texas. According to the Plat thereof recorded under Volume 89166 Page 1974, Map Records, Denton County, Texas.

Town of Addison Project Number 1823-Z

1.1 DESCRIPTION

- A. PROVIDE UNDERGROUND IRRIGATION SLEEVES AS INDICATED ON THE DRAWINGS.

1.3 REFERENCE STANDARDS

- A. SECTION 32 8424 IRRIGATION SYSTEM.
- A. AMERICAN STANDARD FOR TESTING AND MATERIALS (ASTM) LATEST EDITION.

PART 2 - MATERIALS 2.1 GENERAL

- A. POLYVINYL CHLORIDE PIPE (PVC) SCHEDULE 40 SHALL BE USED FOR ALL SLEEVING PURPOSES.
- B. PVC PIPES SHALL BE MARKED WITH SDR NUMBER, ASTM STANDARD NUMBER, AND THE NSF
- C. SOLVENT SHALL BE USED AS RECOMMENDED BY MANUFACTURER TO MAKE SOLVENT WELDED JOINTS. PIPE AND FITTINGS SHOULD BE CLEANED BEFORE APPLYING SOLVENT.

PART 3 - EXECUTION

3.1 INSTALLATION

- A. A MINIMUM OF TWENTY FOUR (24) INCHES COVER SHALL BE PROVIDED OVER THE TOP OF SLEEVE FROM FINISH GRADE.
- B. SLEEVES SHALL BE EXTENDED ONE (1) FOOT PAST THE EDGE OF PAVEMENT OF WALLS. INSTALL A NINETY DEGREE ELBOW ON EACH SLEEVE AND ADD ADDITIONAL LENGTH TO EXTEND ABOVE FINISH GRADE BY TWELVE (12) INCHES. CAP PIPE ENDS.

3.2 BACKFILL

- A. BACKFILL SHALL BE PLACED OVER SLEEVES IN SIX (6) INCH LIFTS. SOIL SHALL BE TAMPED INTO PLACE, TAKING CARE TO NOT DAMAGE SLEEVE.
- B. REPAIR ANY DAMAGE FROM IMPROPER COMPACTION.

END OF SECTION

SECTION 32 8424 - IRRIGATION SYSTEM

- PART 1 GENERAL 1.1 DESCRIPTION
- A. PROVIDE A COMPLETE IRRIGATION SYSTEM INSTALLATION AS DETAILED AND SPECIFIED. THIS SHALL INCLUDE FURNISHING ALL LABOR, MATERIAL, EQUIPMENT AND SERVICES NECESSARY TO
- a. TRENCHING
- c. AUTOMATIC CONTROLLED SYSTEM
- d. AS BUILT DRAWINGS
- B. SLEEVING AS SHOWN SHALL BE FURNISHED BY THE GENERAL CONTRACTOR.
- C. METER AND POWER SHALL BE PROVIDED BY THE GENERAL CONTRACTOR.

PROVIDE COMPLETE INSTALLATION. WORK INCLUDES:

C. REFERENCE IRRIGATION PLANS FOR CONTROLLER, HEAD AND ALL VALVE LOCATIONS.

RRIGATION VALVE BOX: HEAT STAMP

ISOLATION VALVE

FINISH GRADE AT ADJACENT

SURFACE (TURF OR MULCH)

LID WITH 'RCV' IN 2" LETTERS

SIZE PER RCV

MAINLINE AND FITTINGS

THUNTER REMOTE CONTROL VALVE (ICZ) WITH FILTER REGULATOR

LID WITH 'RCV' IN 2" LETTERS

SCH. 80 CLOSE NIPPLE,

MATCH SIZE TO VALVE

IRRIGATION VALVE BOX: HEAT STAMP

FINISH GRADE AT ADJACENT

- ISOLATION VALVE

MAINLINE AND FITTINGS

SURFACE (TURF OR MULCH)

SCH. 80 CLOSE NIPPLE,

- D. REFERENCE LANDSCAPE PLANS, NOTES, DETAILS FOR ADDITIONAL REQUIREMENTS.
- E. SECTION 32 9300 LANDSCAPE
- F. SECTION 32-8423 UNDERGROUND IRRIGATION SLEEVE AND UTILITY CONDUITS

1.3 REFERENCE STANDARDS

A. AMERICAN STANDARD FOR TESTING AND MATERIALS (ASTM) - LATEST EDITION.

HUNTER REMOTE CONTROL ¬

VALVE (ICV) WITH FLOW CONTROL

WATERPROOF

CONNECTORS (2)

18"-24" COILED WIRE -

SIZE PER RCV

BRICK SUPPORTS (4) -

WATERPROOF

CONNECTORS (2)

18"-24" COILED WIRE

FILTER FABRIC - WRAP TWICE _

AROUND BRICK SUPPORTS

3/4" WASHED GRAVEL - 4" MIN. DEPTH

DRIP CONTROL ZONE KIT W/ ISOLATION VALVE

SCH. 80 CLOSE NIPPLE,

MATCH SIZE TO VALVE

IRRIGATION LATERA

BRICK SUPPORTS (4) ~

PVC SLIP X MPT ADAPTOR

TO CONTROLLER

FILTER FABRIC - WRAP TWICE

AROUND BRICK SUPPORTS

3/4" WASHED GRAVEL - 4" MIN. DEPTH-

IN-LINE VALVE (ICV) WITH ISOLATION VALVE

PVC SLIP X FPT ADAPTOR IRRIGATION LATERAL

TO CONTROLLER

1.4 QUALITY ASSURANCE AND REQUIREMENTS

- A. PERMITS AND FEES: THE CONTRACTOR SHALL OBTAIN AND PAY FOR ANY PERMITS NECESSARY AND ALL OBSERVATIONS AS REQUIRED.
- B. MANUFACTURER'S DIRECTIONS: MANUFACTURER'S DIRECTIONS AND DETAILED DRAWINGS SHALL BE FOLLOWED IN ALL CASES WHERE THE MANUFACTURERS OF ARTICLES USED IN THIS CONTRACT FURNISH DIRECTIONS COVERING POINTS NOT SHOWN IN THE DRAWINGS AND
- C. ORDINANCES, CODES, AND REGULATIONS: ALL LOCAL, MUNICIPAL AND STATE LAWS, AND RULES AND REGULATIONS GOVERNING OR RELATING TO ANY PORTION OF THIS WORK ARE HEREBY INCORPORATED INTO AND MADE A PART OF THESE SPECIFICATIONS, AND THEIR PROVISIONS SHALL BE CARRIED OUT BY THE CONTRACTOR. ANYTHING CONTAINED IN THESE SPECIFICATIONS SHALL NOT BE CONSTRUED TO CONFLICT WITH ANY OF THE ABOVE RULES AND REGULATIONS AND REQUIREMENTS OF THE SAME.
- D. HOWEVER, WHEN THESE SPECIFICATIONS AND DRAWINGS CALL FOR OR DESCRIBE MATERIALS, WORKMANSHIP, OR CONSTRUCTION OF A BETTER QUALITY, HIGHER STANDARD OR LARGER SIZE THAN IS REQUIRED BY THE ABOVE RULES AND REGULATIONS, THESE SPECIFICATIONS AND DRAWINGS SHALL TAKE PRECEDENCE.

1.5 SCHEDULE OF MATERIALS

- A. MATERIALS LIST a. ALL EQUIPMENT MANUFACTURERS AND MODEL NUMBERS SHALL BE AS NOTED ON THE
- b. THE CONTRACTOR SHALL FURNISH THE ARTICLES, EQUIPMENT, MATERIALS, OR PROCESSES SPECIFIED BY NAME IN THE DRAWINGS AND SPECIFICATIONS. NO SUBSTITUTION WILL BE

ALLOWED WITHOUT PRIOR WRITTEN APPROVAL OF THE LANDSCAPE ARCHITECT.

- c. A COMPLETE MATERIAL LIST OF EQUIPMENT SHALL BE SUBMITTED BEFORE PERFORMING ANY WORK. SUBMITTAL SHOULD INCLUDE ALL MANUFACTURERS' SPECIFICATIONS AND LITERATURE FOR APPROVAL BY THE LANDSCAPE ARCHITECT PRIOR TO INSTALLATION.
- d. EQUIPMENT OR MATERIALS INSTALLED OR FURNISHED WITHOUT PRIOR APPROVAL OF THE LANDSCAPE ARCHITECT MAY BE REJECTED.
- e. APPROVAL OF ANY ITEM, ALTERNATE OR SUBSTITUTE INDICATES ONLY THAT THE PRODUCT OR PRODUCTS APPARENTLY MEET THE REQUIREMENTS OF THE DRAWINGS AND
- SPECIFICATIONS ON THE BASIS OF THE INFORMATION OR SAMPLES SUBMITTED. f. MANUFACTURER'S WARRANTIES SHALL NOT RELIEVE THE CONTRACTOR OF HIS LIABILITY
- UNDER THE GUARANTEE. SUCH WARRANTIES SHALL ONLY SUPPLEMENT THE GUARANTEE. 1.4 RECORD AND AS BUILT DRAWINGS/SUBMITTALS
- A. CONTRACTOR SHALL PROVIDE AND KEEP UP TO DATE AND COMPLETE "AS-BUILT" RECORD SET
- B. CONTRACTOR SHOULD USE ALL SYMBOLS AND NOTATIONS CONSISTENT WITH THE ORIGINAL
- C. IN "AS-BUILT" DRAWINGS, CONTRACTOR SHALL LOCATE:
- a. CONNECTION TO EXISTING WATER LINES
- b. CONNECTION TO ELECTRICAL POWER
- c. GATE VALVES
- d. ROUTING OF SPRINKLER PRESSURE LINES
- e. SPRINKLER CONTROL VALVES
- f. QUICK COUPLING VALVES
- g. OTHER RELATED EQUIPMENT
- D. SUBMIT COMPLETED TRACINGS PRIOR TO FINAL ACCEPTANCE. DATE AND SIGN ALL DRAWINGS. E. EQUIPMENT TO BE FURNISHED:
- a. SUPPLY AS PART OF THIS CONTRACT THE FOLLOWING TOOLS:
- i. QUICK COUPLING KEYS, THREE (3) WITH BOILER DRAINS ATTACHED USING BRASS REDUCER. ii. THREE (3) KEYS FOR EACH AUTOMATIC CONTROLLER
- b. THE ABOVE MENTIONED EQUIPMENT SHALL BE TURNED OVER TO THE OWNER AT THE CONCLUSION OF THE PROJECT.

STANDARD VALVE BOX DIMENSIONS

■ BOTTOM — →

OPENING 18.72"

MAXIMUM

BOTTOM

STANDARD VALVE BOXES

HUNTER DRIPLINE (HDL) PER PLAN

HUNTER DRIPLINE CONNECTION W/DRIPLINE

\ AND ELBOW

PLD OR PLD-LOC FITTING

FINISHED GRADE

LANDSCAPE PLAN

HDL RISER - LENGTH

PLD OR PLD-LOC FITTING

PVC SUPPLY HEADER

AS REQUIRED

← MULCH PER

F. THE IRRIGATION CONTRACTOR SHOULD DEMONSTRATE THAT THE FINAL INSTALLED SYSTEM

WILL OPERATE ACCORDING TO THE INTENT OF THE DESIGNED AND SPECIFIED SYSTEM. IRRIGATION CONTRACTOR SHALL GUARANTEE 100% COVERAGE TO ALL AREAS TO BE

1.5 MAINTENANCE AND GUARANTEE

- A. MAINTENANCE AND WORKMANSHIP SHALL BE GUARANTEED FULLY FOR ONE (1) YEAR AFTER
- B. PROVIDE MAINTENANCE OF SYSTEM, CLEANING AND ADJUSTMENT OF THE HEADS, FOR ONE (1) YEAR AFTER COMPLETION OF INSTALLATION.
- C. GUARANTEE IS LIMITED TO REPAIR AND REPLACEMENT OF DEFECTIVE MATERIALS AND WORKMANSHIP, INCLUDING THE REPAIR OF BACKFILL SETTLEMENT.

- A. PERFORM TESTING REQUIRED WITH OTHER TRADES INCLUDING EARTHWORK, PAVING, PLUMBING, ETC. TO AVOID CUTTING, PATCHING OR BORING.
- B. WATER PRESSURE SHOULD BE FOUND PRIOR TO STARTING CONSTRUCTION. DETERMINE/CONFIRM THAT STATIC WATER PRESSURE IS MORE THAN THE WATER PRESSURE NEEDED FOR THE SYSTEM TO FUNCTION PROPERTY. IF STATIC PRESSURE IS LESS THAN THE DESIGN PRESSURE NEEDED, DO NOT START WORK UNTIL THE LANDSCAPE ARCHITECT IS

1.7 COORDINATION

- A. COORDINATE INSTALLATION OF ALL PRODUCTS, INCLUDING EARTHWORK, PAVING AND
- B. COORDINATE TO ENSURE THAT ELECTRICAL POWER SOURCE IS IN PLACE.
- C. COORDINATE INSTALLATION WITH WORK SPECIFIED IN OTHER SECTIONS.
- D. COORDINATE WITH THE LANDSCAPE CONTRACTOR TO ENSURE PLANT MATERIAL IS UNIFORMLY WATERED IN ACCORDANCE WITH INTENT SHOWN ON DRAWINGS.

PART 2 - PRODUCTS

- 2.1 MATERIALS B. REFER TO CONSTRUCTION DRAWINGS AND NOTES.
- C. SPRINKLER HEADS IN LAWN AREAS AS SPECIFIED ON PLAN
- D. PVC PIPE: CLASS 200 SPR 21
- E. COPPER TUBING (FOR CITY CONNECTIONS): TYPE "M"
- F. 24V WIRE SIZE 14, TYPE UF
- G. ELECTRIC VALVES TO BE ALL PLASTIC CONSTRUCTION AS INDICATED ON PLANS.
- H. REFER TO DRAWING FOR BACKFLOW PREVENTION LOCATION COORDINATE EXACT LOCATION WITH THE GENERAL CONTRACTOR.

PART 3 - EXECUTION 3.1 INSPECTION:

A. SITE CONDITIONS

- a. ALL SCALED DIMENSIONS ARE APPROXIMATE. THE CONTRACTOR SHALL CHECK AND VERIFY ALL
- b. EXERCISE EXTREME CARE IN EXCAVATING AND WORKING NEAR UTILITIES. CONTRACTOR SHALL BE RESPONSIBLE FOR DAMAGES TO UTILITIES WHICH ARE CAUSED BY ANY OF HIS OPERATIONS
- c. COORDINATE INSTALLATION OF IRRIGATION MATERIALS, INCLUDING PIPE, SO THERE SHALL BE NO INTERFERENCE WITH UTILITIES OR OTHER CONSTRUCTION DIFFICULTY IN PLANTING TREES, SHRUBS, AND GROUNDCOVERS. COORDINATE WORK WITH OTHER SITE CONTRACTORS.

A. PHYSICAL LAYOUT:

— PVC CAP (TYPICAL)

PERMANENT MARKER

1. ALL PVC IRRIGATION SLEEVES TO BE SCHEDULE 40 PIPE 2. ALL JOINTS TO BE SOLVENT WELDED AND WATERTIGHT

SLEEVE TO 24-INCHES MINIMUM ABOVE FINISH GRADE.

4. MECHANICALLY TAMP TO 95% PROCTOR.

IRRIGATION PVC SLEEVES

3. WHERE THERE IS MORE THAN ONE SLEEVE, EXTEND THE SMALLER

5. SLEEVE LOCATIONS SHALL BE MARKED ONTO THE TOP OF CURB WITH

A SAWCUT OF TWO PARALLEL LINES THAT ARE 2" LONG AND 1" APART.

a. PIPING AND HEAD LAYOUT AS SHOWN ON PLANS IS SCHEMATIC ONLY. ALL PIPES TO BE INSTALLED DIRECTLY BEHIND CURBS, WALKS AND WALLS WHEREVER POSSIBLE

PAVEMENT

24" MIN TO

18" MAX.

PVC CAP

(TYPICAL)

FINISH GRADE

- b. PRIOR TO INSTALLATION CONTRACTOR SHALL STAKE OUT ALL PRESSURE SUPPLY LINES, ROUTING AND LOCATION OF SPRINKLER HEADS.
- c. ALL LAYOUTS SHALL BE APPROVED BY THE LANDSCAPE ARCHITECT OR OWNER'S

4" MIN. CLEARANCE

REPRESENTATIVE PRIOR TO INSTALLATION.

INDICATED ON THE DRAWINGS.

- B. WATER SUPPLY:
- a. IRRIGATION SYSTEM SHALL BE CONNECTED TO WATER SUPPLY POINTS OF CONNECTION AS
- b. CONNECTIONS SHOULD BE MADE AT APPROXIMATE LOCATIONS AS SHOWN ON DRAWINGS. CONTRACTOR SHALL VERIFY IN FIELD AND BE RESPONSIBLE FOR MINOR CHANGES CAUSED BY ACTUAL SITE CONDITIONS.

3.3 INSTALLATION

A. TRENCHING

SECTION VIEW

AND BESIDE MAINLINE. PLASTIC PIPING TO AT CHANGES OF DIRECTION OF 30° BE SNAKED IN

1. SLEEVE BELOW ALL HARDSCAPE ELEMENTS WITH SCH 40 PVC TWICE THE

2. FOR PIPE AND WIRE BURIAL DEPTHS, SEE SPECIFICATIONS. MINIMUM - 12"

PIPE

AND WIRING IN THE MAINLINE LATERAL

SAME TRENCH

RUN WIRING BENEATH ALL SOLVENT WELD

10-FOOT INTERVALS. TRENCH AS SHOWN.

DIAMETER OF THE PIPE OR WIRE BUNDLE WITHIN.

PIPE AND WIRING TRENCHING

3. BACKFILL AND COMPACT TRENCHES TO ORIGINAL GRADE.

PIPE

- a. DIG TRENCHES STRAIGHT 6" WIDE WITH NEAR VERTICAL SIDE AND SUPPORT PIPE CONTINUOUSLY ON BOTTOM OF TRENCH. REMOVE LUMBER, RUBBISH, LARGE ROCKS ETC. FROM TRENCHES. LAY PIPE TO AN EVEN GRADE - WITH A FIRM, UNIFORM BEARING FOR
- b. REMOVE FOREIGN MATTER OR DIRT FROM INSIDE OF PIPE BEFORE WELDING AND KEEP PIPING CLEAN BY ANY MEANS POSSIBLE DURING AND AFTER LAYING OF PIPE.
- c. PROVIDE A MINIMUM OF EIGHTEEN (18) INCHES OF COVER FOR ALL PRESSURE SUPPLY LINES. d. PROVIDE A MINIMUM OF TWELVE (12) INCHES OF COVER FOR ALL NON-PRESSURE LINES.
- e. PROVIDE A MINIMUM COVER OF EIGHTEEN (18) INCHES FOR ALL CONTROL WIRING.
- f. NO MACHINE TRENCHING, UNLESS APPROVED BY THE LANDSCAPE ARCHITECT, SHALL BE DONE WITHIN DRIP LINE OF EXISTING TREES. TRENCHING SHOULD BE DONE BY HAND, TUNNELING OR BORING OR OTHER METHODS APPROVED BY THE LANDSCAPE ARCHITECT. IT SHOULD BE UNDERSTOOD THAT PIPING LAYOUT IS DIAGRAMMATIC AND PIPING SHALL BE ROUTED AROUND TREES AND SHRUBS IN SUCH A MANNER TO AVOID DAMAGE TO PLANTS.
- a. TRENCHES SHALL NOT BE BACKFILLED UNTIL ALL REQUIRED TESTS ARE PERFORMED. TRENCHES SHALL BE CAREFULLY BACKFILLED WITH THE EXCAVATED MATERIALS APPROVED FOR BACKFILLING, CONSISTING OF EARTH, LOAM, SANDY CLAY, SAND OR OTHER APPROVED
- b. IF SETTLEMENT OCCURS AND SUBSEQUENT ADJUSTMENTS IN PIPE, VALVES, SPRINKLER HEADS, LAWN OR PLANTING OR OTHER CONSTRUCTION ARE NECESSARY, THE CONTRACTOR SHALL MAKE ALL REQUIRED ADJUSTMENTS WITHOUT THE COST TO THE OWNER.

MATERIALS, FREE FROM LARGE CLODS, STONES OR STICKS.

- TRENCHING AND BACKFILL UNDER PAVING: a. ALL IRRIGATION MAIN LINE AND LATERAL LINES OR WIRING LOCATED UNDER AREAS WHERE
- PAVING, ASPHALTIC PAVING, OR CONCRETE SHALL BE INSTALLED IN SCHEDULE 40 PVC SLEEVES OF ADEQUATE SIZE. SEE SECTION 32 8423.
- a. INSTALL ALL ASSEMBLIES SPECIFIED HEREIN IN ACCORDANCE WITH RESPECTIVE DETAILS. IN ABSENCE OF DETAIL DRAWINGS OR SPECIFICATIONS, PERFORM SUCH WORK IN ACCORDANCE WITH BEST STANDARD PRACTICES OR MANUFACTURER'S RECOMMENDATIONS AS APPROVED
- b. MAKE SOLVENT WELDED JOINTS USING ONLY THE SOLVENT RECOMMENDED BY THE MANUFACTURER. PIPES AND FITTINGS SHOULD BE CLEANED OF ALL DIRT AND DUST AND MOISTENED BEFORE APPLYING SOLVENT.
- c. ON PVC TO METAL CONNECTIONS, THE CONTRACTOR SHALL WORK METAL CONNECTIONS FIRST. USE NON HARDENING PIPE DOPE OR TEFLON TAPE ON THREADED PVC ADAPTERS INTO WHICH PIPE MAY BE WELDED. LIGHT WRENCH PRESSURE IS ALL THAT IS REQUIRED, USE THREADED PVC ADAPTERS INTO WHICH THE PIPE MAY BE WELDED.
- E. LINE CLEARANCE: ALL LINES SHALL HAVE A MINIMUM CLEARANCE OF SIX (6) INCHES FROM EACH OTHER AND FROM OTHER TRADES. PARALLEL LINES SHALL NOT BE DIRECTLY INSTALLED ONE OVER THE OTHER.
- F. WIRING: SUPPLY WIRE FROM THE AUTOMATIC CONTROLLER TO ALL THE VALVES. A SEPARATE WIRE IS REQUIRED TO EACH ELECTRIC VALVE. A COMMON NEUTRAL WIRE IS ALSO REQUIRED FROM EACH CONTROL TO EACH OF THE VALVES. BUNDLE MULTIPLE WIRES AND TAPE THEM TOGETHER AT TEN FOOT INTERVALS. EXPANSION COILS OF TEN INCHES SHALL BE INSTALLED APPROXIMATELY EVERY 100 FEET. MAKE ALL SPLICES WATERPROOF.
- G. AUTOMATIC CONTROLLER: INSTALL AS PER MANUFACTURER'S SPECIFICATIONS AND

WIRING IN CONDUIT

WIRE W/O CONDUIT

OR GREATER. UNTIE AFTER ALI

CONNECTIONS HAVE BEEN MADE

INSTRUCTIONS. REMOVE CONTROL VALVES SHALL BE CONNECTED TO CONTROLLER IN NUMERICAL SEQUENCE AS SHOWN ON THE DRAWINGS. EACH REMOVE CONTROL VALVE SHALL BE WIRED TO ONE STATION OF THE CONTROLLER.

- H. REMOTE CONTROL VALVES:
- a. INSTALL WHERE SHOWN ON DRAWINGS AND DETAILS. VALVES SHALL BE SIZED ACCORDING
- TO THE DRAWINGS. b. INSTALL IN A LEVEL POSITION IN ACCORDANCE TO MANUFACTURER'S SPECIFICATIONS.
- c. WHEN GROUPED TOGETHER, ALLOW AT LEAST TWELVE (12) INCHES BETWEEN VALVES. INSTALL EACH REMOTE CONTROL VALVE IN A SEPARATE VALVE BOX. EACH VALVE NUMBER AND ITS CONTROLLER LETTER SHALL BE STENCILED INSIDE VALVE BOX TOP WITH EXTERIOR
- FLUSHING OF SYSTEM:
- a. AFTER ALL NEW SPRINKLER PIPE LINES AND RISERS ARE IN PLACE AND CONNECTED, ALL NECESSARY WORK HAS BEEN COMPLETED, AND PRIOR TO INSTALLATION OF SPRINKLER HEADS, THE CONTROL VALVES SHALL BE OPENED AND A FULL HEAD OF WATER USED TO FLUSH OUT
- b. SPRINKLER HEADS SHALL BE INSTALLED ONLY AFTER FLUSHING OF THE SYSTEM HAS BEEN ACCOMPLISHED.

SPRINKLER HEADS:

DETAILS ON DRAWINGS.


- a. INSTALL HEADS AS DESIGNED ON THE DRAWINGS. MAKE APPROPRIATE ADJUSTMENTS TO HEAD LAYOUT TO ACCOMMODATE FOR ACTUAL FIELD CONDITIONS.
- b. SPACING OF HEADS SHALL NOT EXCEED THE MAXIMUM INDICATED ON THE DRAWINGS. IN NO CASE SHALL THE SPACING EXCEED THE MAXIMUM RECOMMENDED BY THE MANUFACTURER. c. ALL SPRINKLERS TO ATTACH TO LATERAL LINES WITH FLEXIBLE CONNECTORS. REFERENCE


3.4 TESTING

- A. THE CONTRACTOR SHALL TEST SPRINKLER MAIN FOR TWELVE TO FOURTEEN HOURS UNDER NORMAL PRESSURE. IF LEAKS ARE PRESENT, REPLACE JOINT OR JOINS AND REPEAT TEST.
- B. A COMPLETE TEST SHALL BE MADE PRIOR TO BACKFILLING. BACKFILLING MATERIALS MAY BE PLACED IN TRENCHES IN LIFTS TO ENSURE STABILITY OF THE LINE UNDER THE PRESSURE OF BACKFILL. IN EACH CASE, LEAVE FITTINGS AND COUPLINGS OPEN TO VISUALLY INSPECT FOR FULL PERIOD OF TEST.
- C. WHEN SYSTEM IS COMPLETE, A COVERAGE TEST SHALL BE PERFORMED IN THE PRESENCE OF THE LANDSCAPE ARCHITECT OR OWNER'S REPRESENTATIVE. IT SHALL BE DETERMINED IF THE WATER COVERAGE FOR ALL PLANTING AREAS IS COMPLETE AND ADEQUATE. FURNISH ALL MATERIALS AND PERFORM ALL WORK REQUIRED TO CORRECT ANY INADEQUACIES OF
- D. UPON COMPLETION OF EACH PHASE OF WORK, THE ENTIRE SYSTEM SHOULD BE TESTED AND ADJUSTED TO MEET SITE REQUIREMENTS.

END OF SECTION

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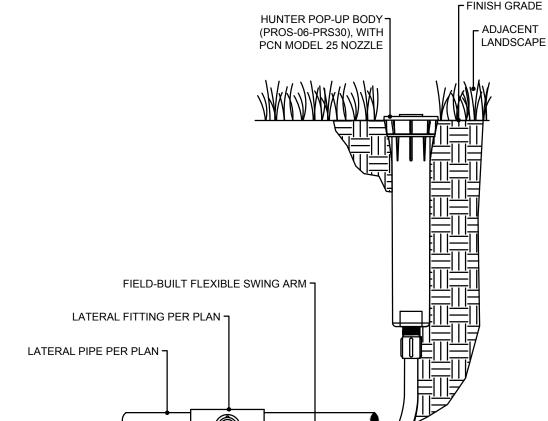


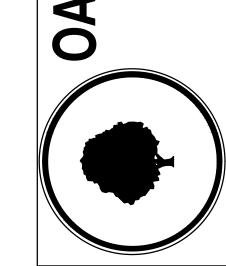
ISSUE DATE 9 FOR COUNCIL REVIEW
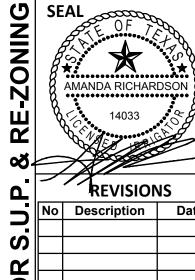
> SHEET TITLE **IRRIGATION SPECS AND DETAILS**


02/26/21

SHEET NO.




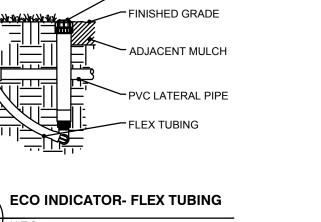


ECO INDICATOR

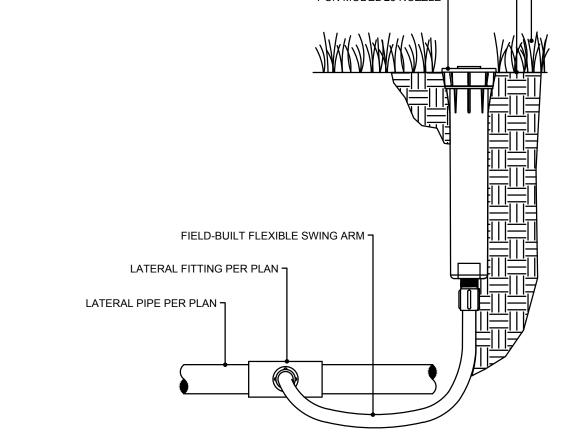



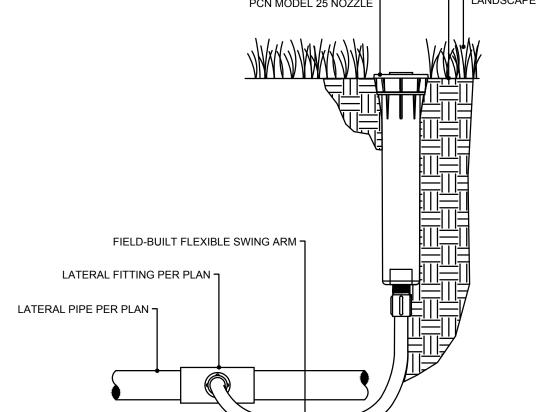

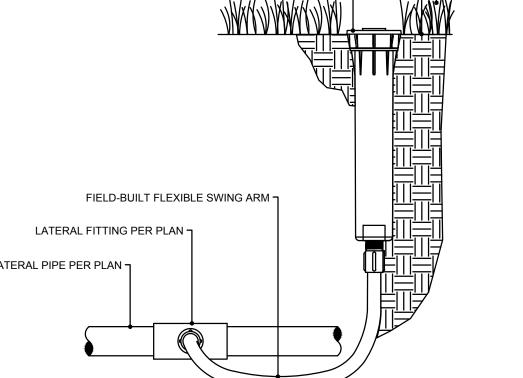

PLD OR PLD-LOC FITTINGS TYP. AIR RELIEF VALVE IN VALVE BOX PLD TUBING EXHAUST HEADER - ECO-INDICATOR ON SWING ARM - HDL TUBING SUPPLY - DRIP CONTROL ZONE KIT PER PLAN

HUNTER DRIPLINE (HDL) PER PLAN

FLUSH POINT IN SUBTERRANEAN BOX PER PLAN

1. AIR RELIEF VALVE INSTALLED IN VALVE BOX AT OPTIMAL HIGHEST POINT FROM CONTROL ZONE KIT. MULTIPLE AIR RELIEF VALVES MAY BE NEEDED TO ACCOMMODATE DIFFERENCES IN GRADE.

IN CLEAR VIEW WHEN POPPED UP. 3. FLUSH POINT TO BE INSTALLED AT OPTIMAL FURTHEST POINT FROM CONTROL ZONE KIT TO ALLOW FOR MAXIMUM DEBRIS FLUSH IN SYSTEM.

\ HUNTER DRIPLINE- PLANTING BED CENTER FEED

2. ECO-INDICATOR TO BE INSTALLED AT OPTIMAL FURTHEST POINT FROM CONTROL ZONE KIT

to the City of Addison, Dallas County Texas. According to the Plat thereof recorded under Volume 89166 Page 1974, P.O. Box 1746 Aledo, Texas 76008 Map Records, Denton County, Texas. amanda@awr-designs.com 512.517.5589

Town of Addison Project Number_1823-Z

Being Lot 2 of Addison Oaks Addition

Date

COUNCIL

Date Initials See the Staff Approval Letter or Council Result Memo for any

APPROVED

<u>ACTION</u>

DENIED

Initials

conditions associated with the approval of the project. ARCHITECT

KIRK & ASSOCIATES ARCHITECTURE INTERIOR DESIGN PLANNING


5931 GREENVILLE AVE #772 DALLAS, TEXAS 75206 PHONE 214-912-7642

kirkarch1@aol.com

www.kirkarchitecture.com


DEVELOPER PROPERTY OWNER BARNETT/ADDISC

ELLIOT B. BARNET CLINT NORTON 3132 FOREST PARK BLV FT. WORTH, TEXAS 7511 Cell: 214-393-3515 Email: Email: clint@oakdbbq.com

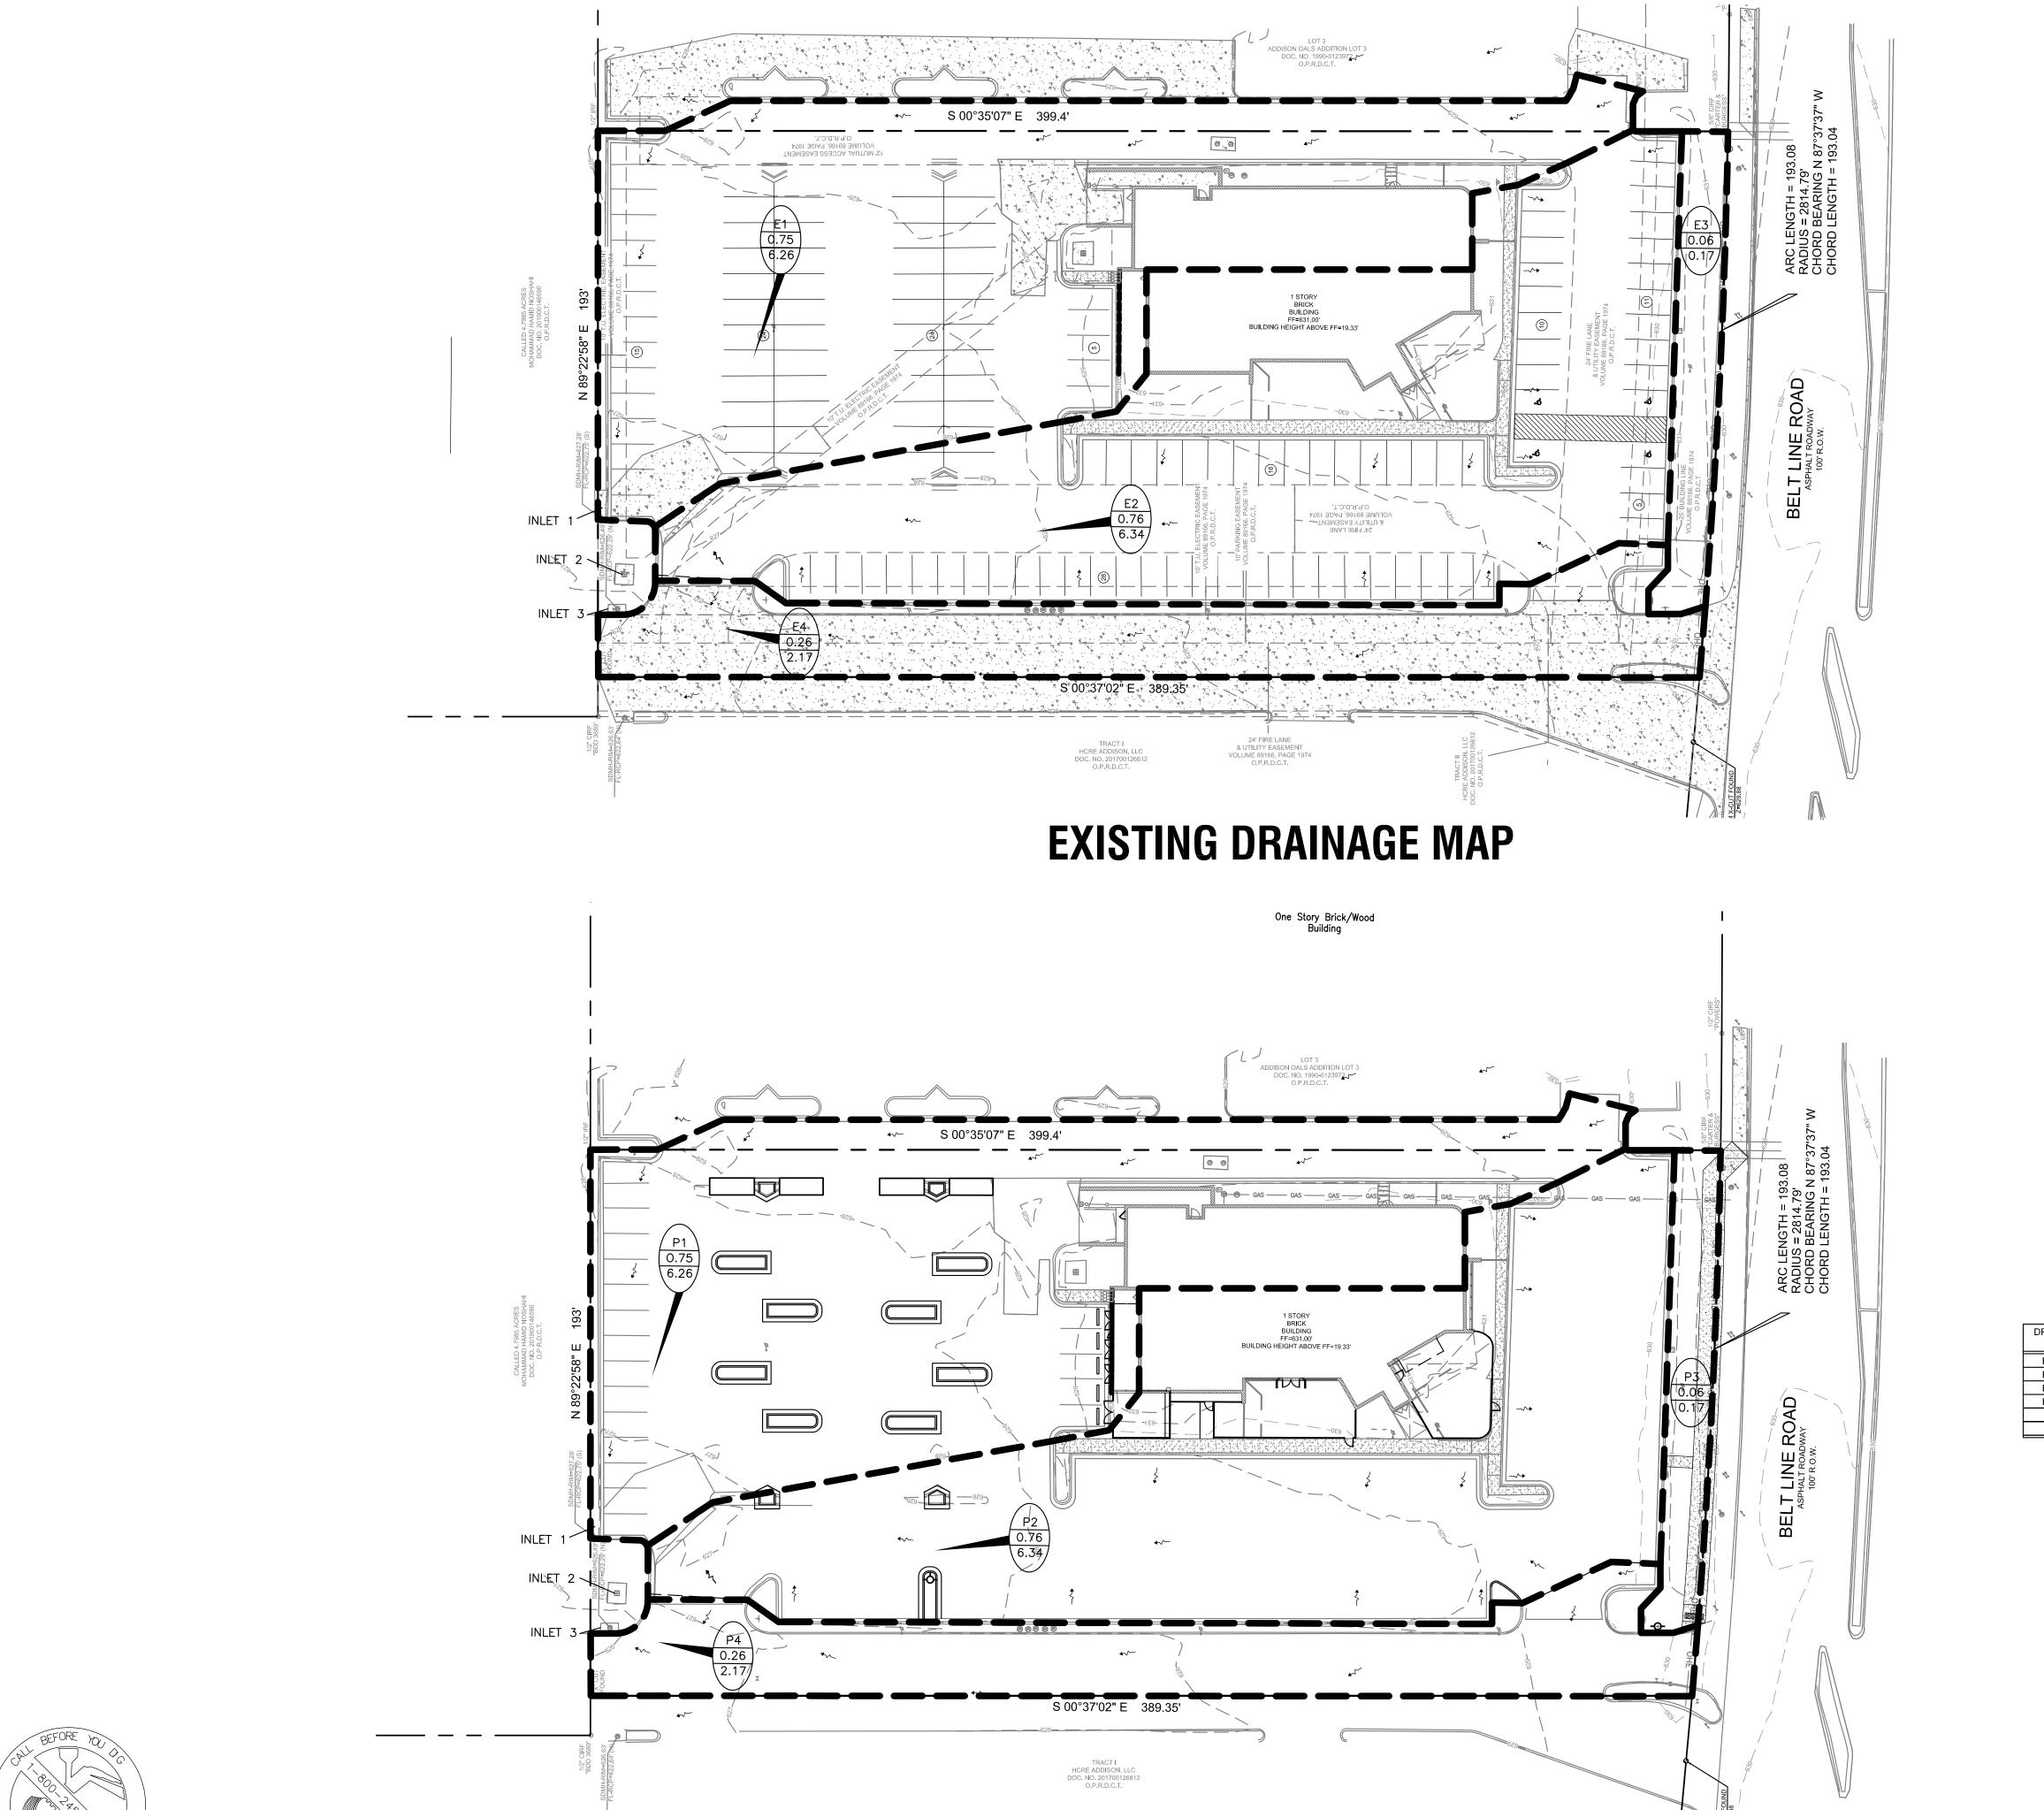


PROPOSED DRAINAGE MAP

TEXAS EXCAVATION SAFETY SERVICES 1-800-344-8377

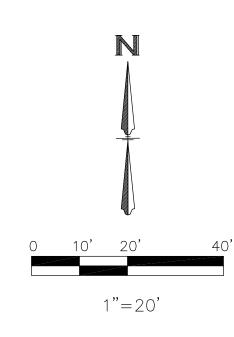

DRAINAGE LEGEND:

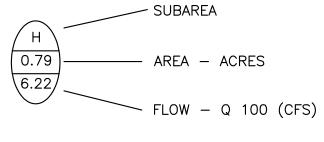

DRAINAGE AREA LINE

DRAINAGE NOTES:

- 1. THE DEVELOPER, THROUGH HIS ENGINEER OR AUTHORIZED REPRESENTATIVE, SHALL ACQUIRE ALL REQUIRED NATIONWIDE PERMITS, SUCH AS CWA 401, 402 AND/OR 404 PERMITS, AS APPROPRIATE, FROM THE USEPA, TCEQ, AND/OR USACE.
- 2. TOPOGRAPHICAL INFORMATION IS PRESENTED FOR DRAINAGE ANALYSIS PURPOSES ONLY AND IS NOT TO BE USED FOR CONSTRUCTION.
- 3. TOPOGRAPHICAL INFORMATION PRESENTED HEREIN IS DERIVED FROM SURVEY AS PROVIDED BY EAGLE
- 4. THE SITE IS COMPLETELY DEVELOPED. OUR PROPOSED CONDITIONS ARE NOT CHANGED FROM THE EXISTING CONDITIONS. WE ARE NOT PROPOSING ANY NEW IMPERVIOUS AREAS. IN FACT WE ARE SLIGHTLY REDUCING THE AMOUNT OF IMPERVIOUS.

DRAINAGE SUMMARY

100 YR STORM						
RAINAGE AREA	AREA (AC)	Tc (MIN)	C-VALUE	l (100 yr) (in/hr)	Q (100 yr) (cfs)	REMARKS
E1 & P1	0.75	10	0.90	9.27	6.26	DRAINAGE TO INLET #1
E2 & P2	0.76	10	0.90	9.27	6.34	DRAINAGE TO INLET #2
E3 & P3	0.06	10	0.30	9.27	0.17	DRAINAGE TO BELTLINE ROAD
E4 & P4	0.26	10	0.90	9.27	2.17	DRAINAGE TO INLET #3
		l		· · · · · · · · · · · · · · · · · · ·	I	1

APPROVED

COUNCIL

See the Staff Approval Letter or Council Result Memo for any conditions associated with the

ARCHITECT

approval of the project.

KIRK & ASSOCIATES ARCHITECTURE
INTERIOR DESIGN
P L A N N I N G 5931 GREENVILLE AVE #772 DALLAS, TEXAS 75206 PHONE 214-912-7642

kirkarch1@aol.com www.kirkarchitecture.com

DEVELOPER PROPERT

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STAL CONJUSTS COURS

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ELLIOT B. BARNETT
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Cell: 214-393-3515
Email:

5814 Coolwater Cove DALLAS, TEXAS 75252 Cell: 214-546-9999 Email: clint@oakdbbq.com

REVISIONS Description Date

Being Lot 2 of Addison Oaks Addition to the City of Addison, Dallas County Texas. According to the Plat thereof recorded under Volume 89166 Page 1974, Map Records, Denton County, Texas. **ISSUE DATE**

FOR COUNCIL REVIEW 02/26/21

Town of Addison Project Number 1823-Z

The Bousquet Group, LLC

Engineer Information:

5104 Connors Dr. Flower Mound, TX

972.207.8077

Texas Firm No. F-8942

SHEET TITLE

DRAINAGE AREA MAP

